ADDENDUM #2 - MARCH 3, 2025

RE: CITY OF PORT ORFORD

Community Building Remodel

Project #18.27.2

FROM: HGE ARCHITECTS, Inc.

333 South 4th Street

Coos Bay, Oregon 97420

541-269-1166

TO: Prospective Bidders

This Addendum forms a part of the Contract Documents and modifies the original Documents dated February 2025, as noted below. Acknowledge receipt of this Addendum in the space provided on the Bid Form. Failure to do so may subject Bidder to disqualification.

COOS BAY, OREGON

This Addendum consists of **FIVE (5)** page(s) together with the following attachments:

- Sheet S1.1 Foundation Plan
- Sheet S5.1 Structural Details
- Sheet S5.2 Structural Details
- Sheet M2.1 HVAC Floor Plan
- Sheet E3.0 Electrical Plans Power & Signal

CHANGES TO PROJECT MANUAL:


- 1. Section 00-4100 Bid Form, Paragraph 1.05: ADD "H. By signing this Proposal, the Bidder certifies that the provisions required by the Davis-Bacon Act concerning payment rate of wages shall be included in this Contract, are understood by the Bidder, and will be complied with during the Work. See Section 00-7346 Prevailing Wage Rates."
- 2. Section 00-7346 Prevailing Wage Rates, Paragraph 1.01: ADD "G. Refer to Davis-Bacon Wage General Decision Number: OR20250065 dated 1/3/25. Contractor shall pay each worker employed in the performance of this contract not less than the higher of the wage rate for the type of work being performed as set forth in either the Oregon Prevailing Wage set forth in the "Prevailing Wage Rates for Public Works Contracts in Oregon" or the applicable federal Davis-Bacon Wage Decision."
- 3. Section 06-2000 Finish Carpentry, Paragraph 2.04 B: DELETE "plain sawn."
- **4. Section 23-3400 HVAC Fans:** ADD the following Paragraph 2.02:

- 2.02 Exhaust Fan System Controls
 - A. See drawings for controls associated with exhaust fans to interlock with other HVAC devices.
 - B. Provide all control relays, current sensors and low voltage wiring between control devices and fans. Control devices that are not duct mounted or wall mounted shall be installed in a Hoffman or equal control enclosure. All control wire shall be installed in conduit or may be installed exposed in mechanical rooms if secured at least 18" OC and routed to match building lines or duct runs.
 - C. Cooling only thermostat to be line voltage, Bi-Metallic spring type. Dayton 6GVX8C or equal. Coordinate with Div.26 for wiring through device to fan.

CHANGES TO DRAWINGS:

- 1. Sheet S0.1 General Structural Notes & SIS:
 - a. ADD the following:
 - IV. Structural Steel Framing
 - 1. Materials:
 - a. Channels, angles, plates, and bars: ASTM A36.
 - 2. Fasteners:
 - a. Machine Bolts: ASTM A307
 - b. Bolts: ASTM F3125
 - c. Anchor Rods: ASTM F1554, Grade 36, threaded with nut, unless otherwise noted, and hooked for anchoring wood sole plates.
 - d. Nuts: ASTM A563
 - b. At VI. Cold-Formed Steel Framing, 2. Materials, ADD "B. Joists and Girts: Fy = 50 KSI."
 - c. At VI. Cold-Formed Steel Framing, 3. Fasteners, ADD "ii. #12 = 0.126" DIA., 0.340" head."
- 2. Sheet S1.1 Foundation Plan: REPLACE with the attached revised sheet in its entirety. Revisions include additional Z-girt in east wall.
- 3. Sheet S2.2 Roof Framing Plan: At header (HDR) at barn door opening at southeast corner of American Legion Building, REPLACE "4x8" with "4x12."
- **4. Sheet S5.1 Structural Details:** REPLACE with the attached revised sheet in its entirety. Revisions include:
 - a. Revised Detail 9 with additional Z-girt.
 - b. Added Section B-B to Detail 9 at additional Z-girt.

- **5. Sheet S5.2 Structural Details:** REPLACE with the attached revised sheet in its entirety. Revisions include added Detail 4, Additional Girt Connection to Frame.
- **6. Sheet P1.0 Plumbing Demo Plan:** ADD dashed water meter and CW line into building at southeast corner of building, with notes: "Water meter removal by City" and "Remove piping."
- 7. Sheet M2.1 HVAC Floor Plan: REPLACE with the attached revised sheet in its entirety. Revisions include:
 - a. Revised sizing of Supply Air Main off FC/1.
 - b. Added a transition to 22x9 SA after main take-off to serve Multi-Purpose.
 - c. Added note for lining on RA plenum for 48x48 Low RA Grille.
- 8. Sheet M6.0 Mechanical Schedules, Exhaust Fans Schedule:
 - a. At Control column for Design Symbol 'EF-2 thru 6,' ADD "Note #1."
 - b. In 'Notes' line, ADD "#1: See 8/M6.1 for exhaust fan detail."
- 9. Sheet E1.0 Electrical Plans Symbols & Schedules, Panel 'CB2' Schedule:
 - a. ADD stage speaker receptacles to 20/1 breaker in Panel CB2-13.
 - b. REPLACE Panel CB-2 blank spaces with spare 20/1 breakers.
- **10. Sheet E1.2 Electrical Plans Demolition:** ADD the following Detail 2/E1.2 Door Elevation, Security Detail:

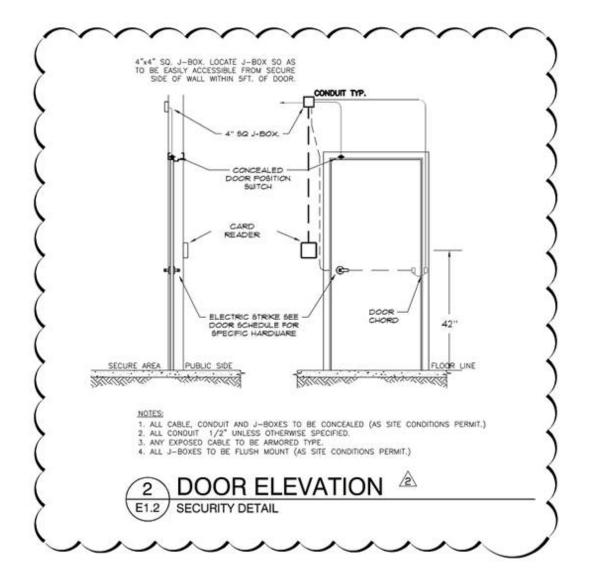


11.Sheet E3.0 Electrical Plans Power & Signal: REPLACE with the attached revised sheet in its entirety. Revisions include:

- a. Access control at Door #s 1A, 1B, 9, and 15B per Addendum #1. Access control panel added in AV Closet.
- b. Revised speaker layout and added electrical rough-in at revised locations.
- c. Added speaker receptacles for future use.
- d. Relocated Panel CB1 next to Door #15A.
- e. Relocated Fire Alarm Control Panel next to Door #15B.

SUBSTITUTION APPROVALS:

SPECIFIED SECTION	SPECIFIED ITEM	APPROVED
08-1113 Hollow Metal Doors & Frames	Hollow Metal Doors & Frames Stainless-Steel Hollow Metal Doors & Frames	National Custom Hollow Metal
03-3511 Concrete Floor Finishes	Joint Filler	Hi-Tech Systems PE85 MI

END OF ADDENDUM #2

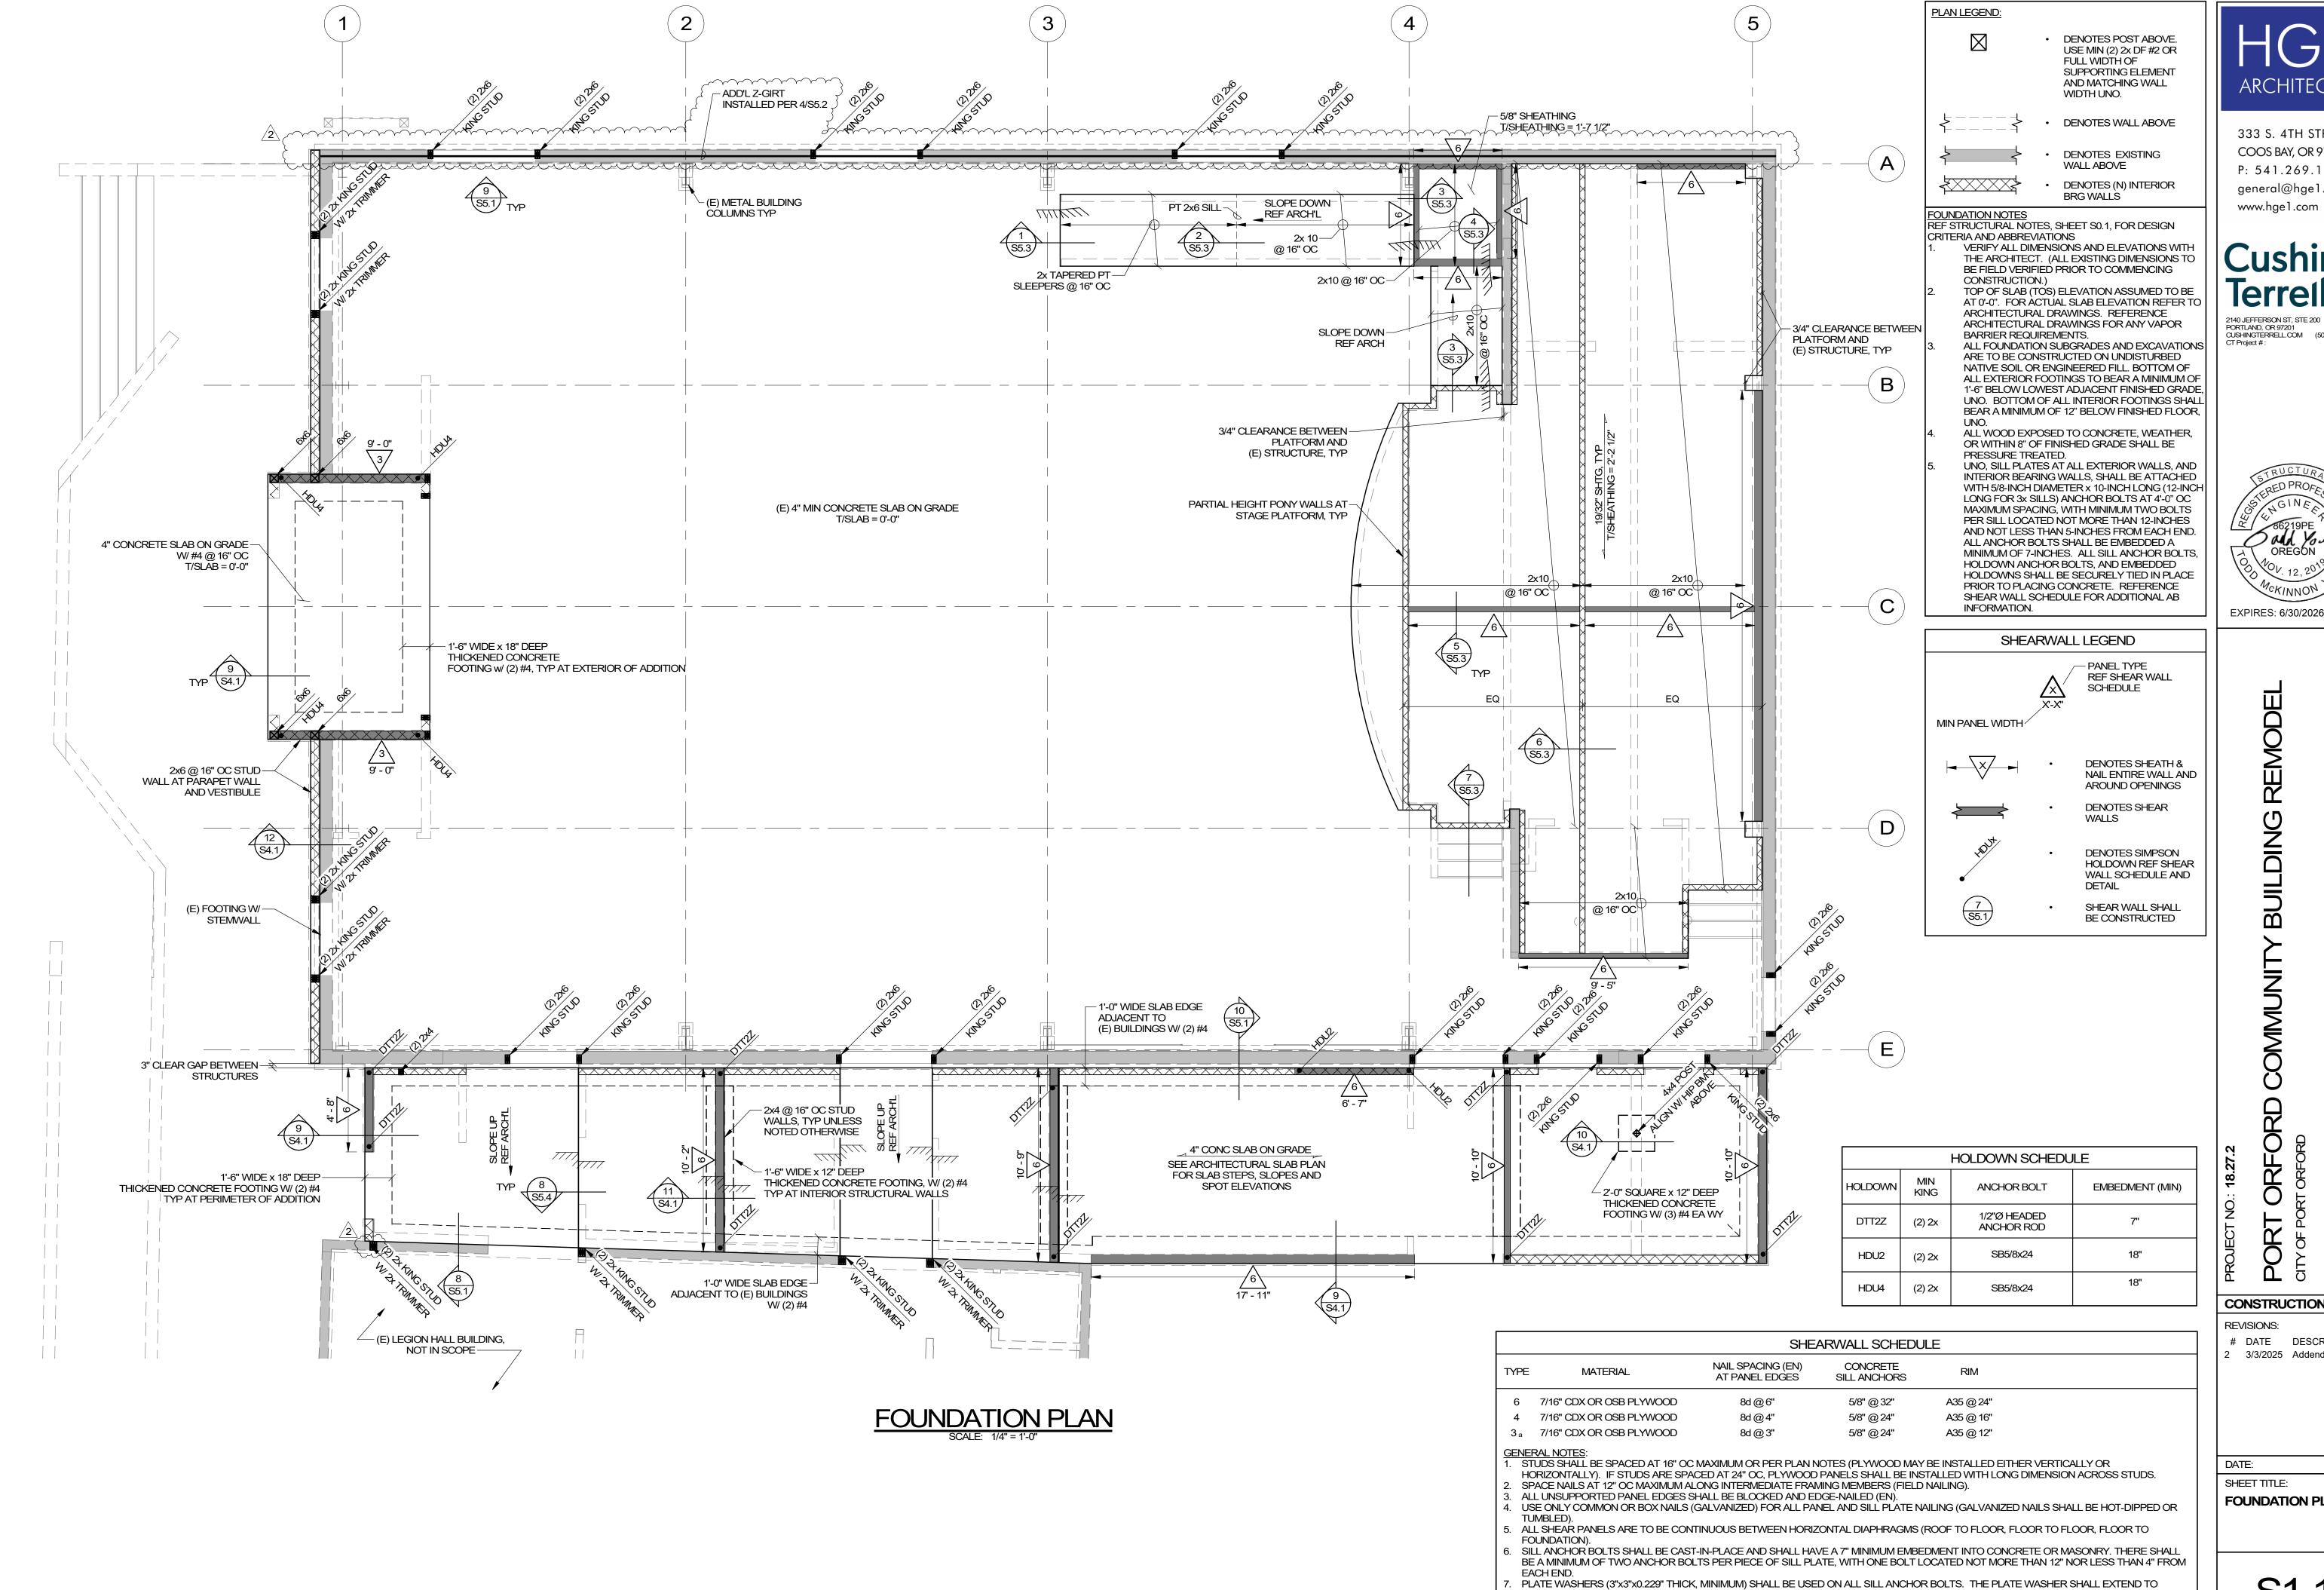

WITHIN 1/2" OF THE EDGE OF THE SILL PLATE.

B. 3x MEMBERS MAY BE SUBSTITUTED WITH (2) 2x MEMBERS NAILED TOGETHER WITH 10d NAILS @ 4" OC.

FOOTNOTES:
a. STUDS AND/OR BLOCKING AT ADJOINING PANEL EDGES SHALL BE 3x MINIMUM AND NAILS SHALL BE STAGGERED. SILL PLATES SHALL BE 3x

ARCHITECTS

333 S. 4TH STREET COOS BAY, OR 97420 P: 541.269.1166 general@hge1.com

PORTLAND, OR 97201 CUSHINGTERRELL.COM (503) 395-1229

EXPIRES: 6/30/2026

CONSTRUCTION


REVISIONS: # DATE DESCRIPTION

2 3/3/2025 Addendum #2

1.31.2025

SHEET TITLE: FOUNDATION PLAN

S1.1

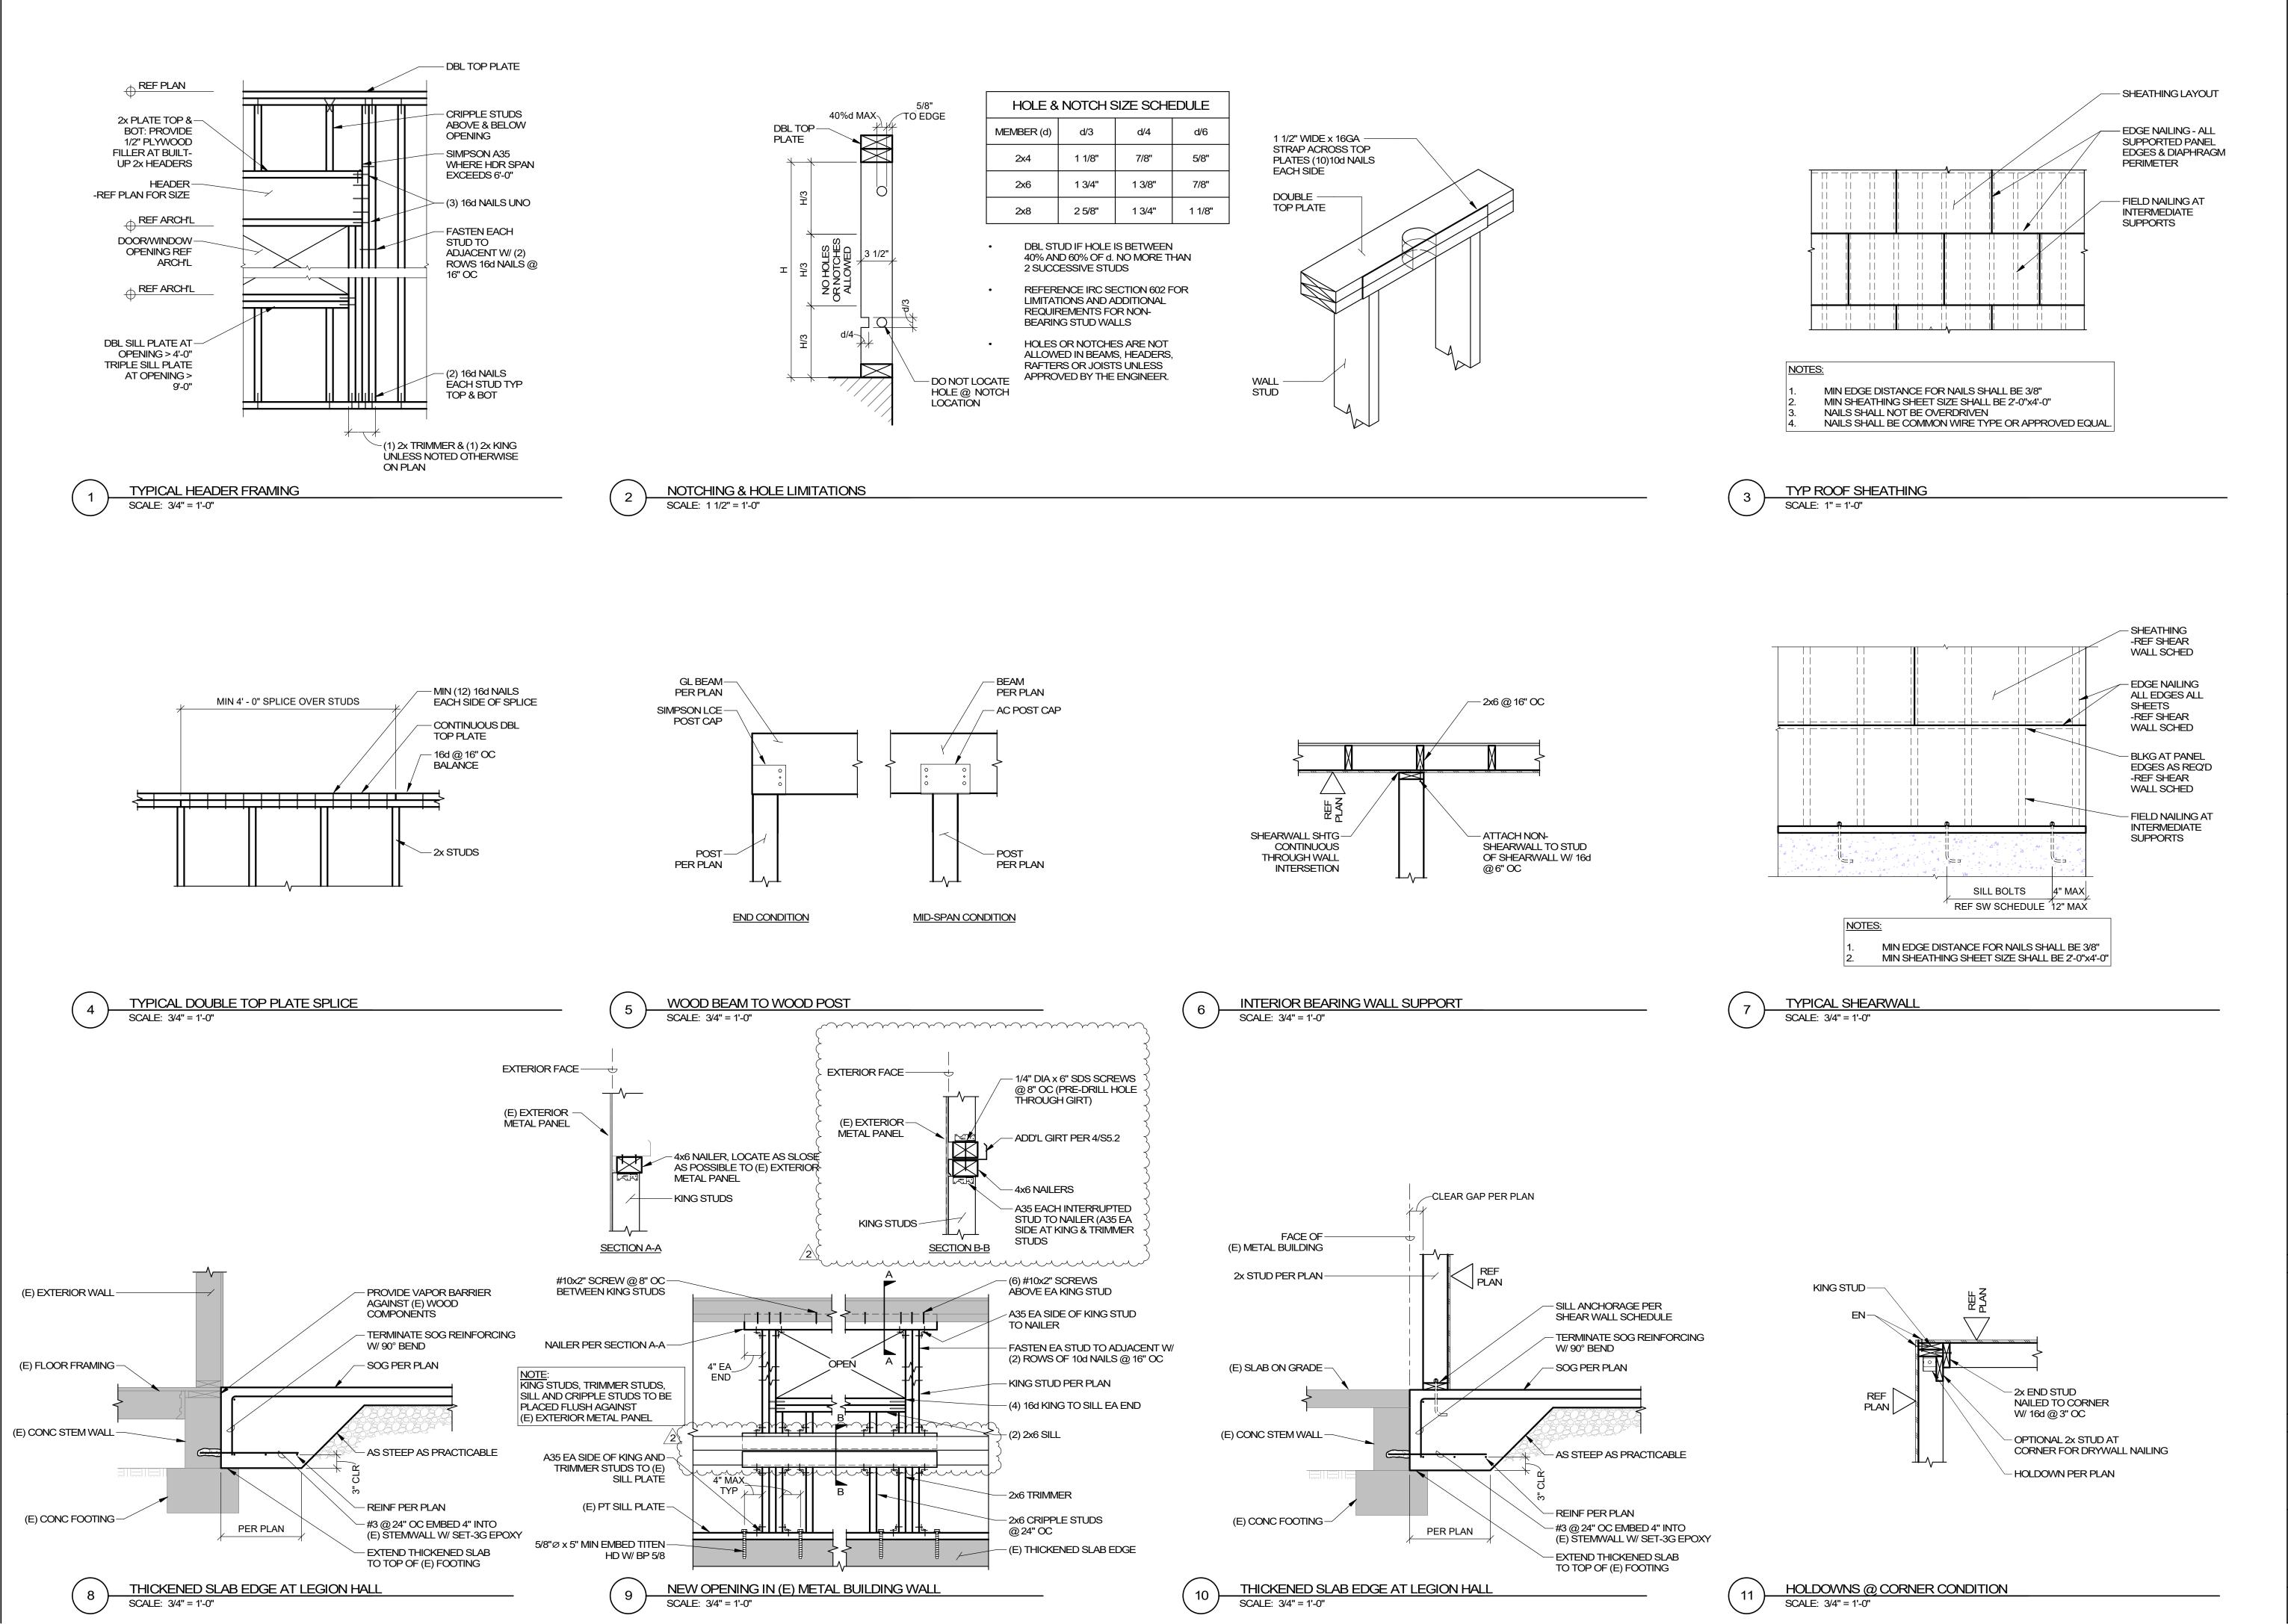

333 S. 4TH STREET COOS BAY, OR 97420 P: 541.269.1166 general@hge1.com www.hge1.com

2140 JEFFERSON ST, STE 200
PORTLAND, OR 97201
CUSHINGTERRELL.COM (503) 395-1229
CT Project #: 24-10-245

EXPIRES: 6/30/2026

CONSTRUCTION

DATE DESCRIPTION 2 3/3/2025 Addendum #2

1.31.2025 DATE: SHEET TITLE: STRUCTURAL **DETAILS**

S5.1

- 2x FASTENED TO POST W/

1/4" Øx4 1/2 SDS SCREWS

@8" OC FULL HT


PER PLAN

(2) 2x FASTENED TO POST W/-

SCALE: 3/4" = 1'-0"

1/4"Øx6" SDS @ 8" OC FULL

SECTION AT VESTIBULE SHEARWALL

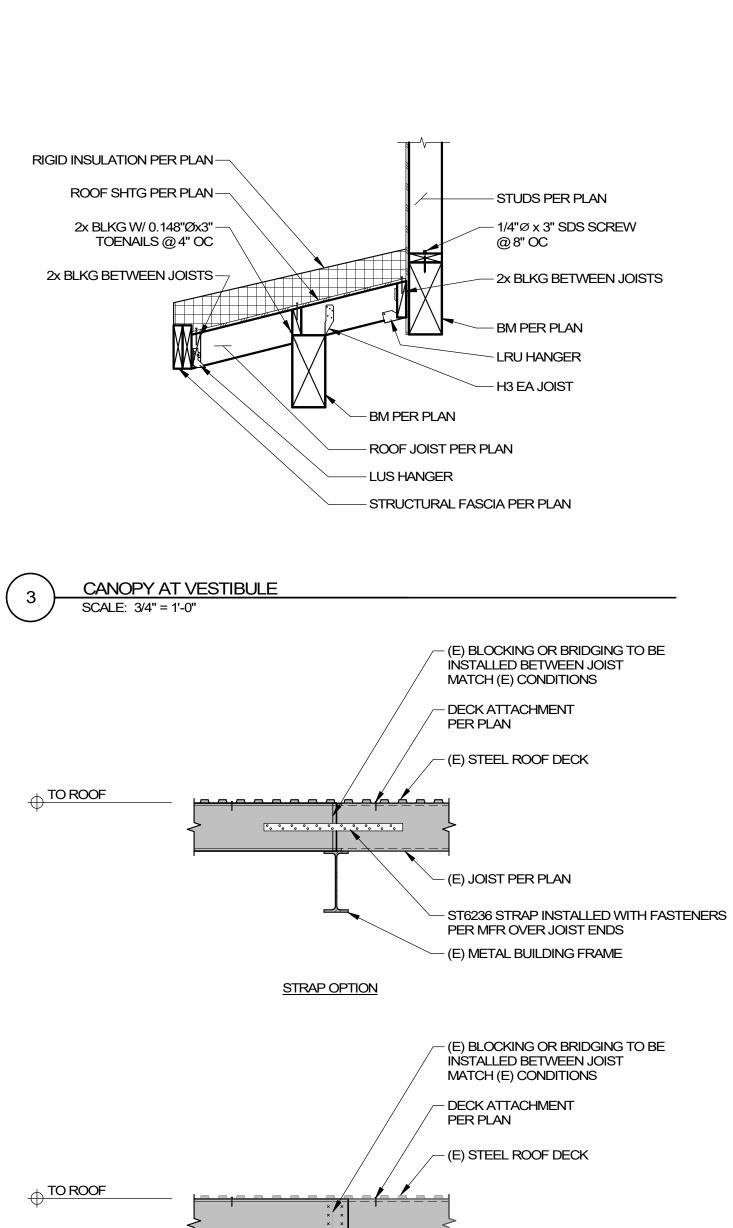


JOIST SPLICE OPTION

SCALE: 3/4" = 1'-0"

- (E) JOIST PER PLAN

- (10) #10 SCREWS AT JOIST LAP

- (E) METAL BUILDING FRAME

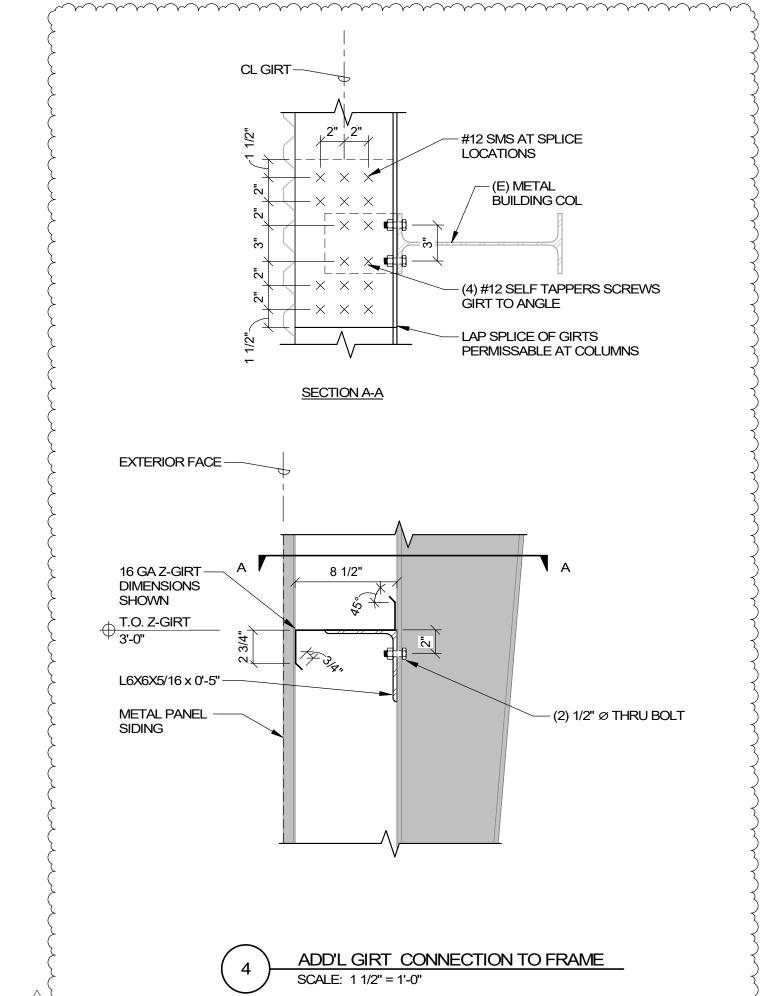

EXPIRES: 6/30/2026

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CONSTRUCTION

REVISIONS:

DATE DESCRIPTION 2 3/3/2025 Addendum #2

DATE: SHEET TITLE:

STRUCTURAL **DETAILS**


S5.2


1.31.2025

ARCHITECTS

333 S. 4TH STREET COOS BAY, OR 97420

M2.1

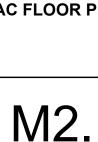

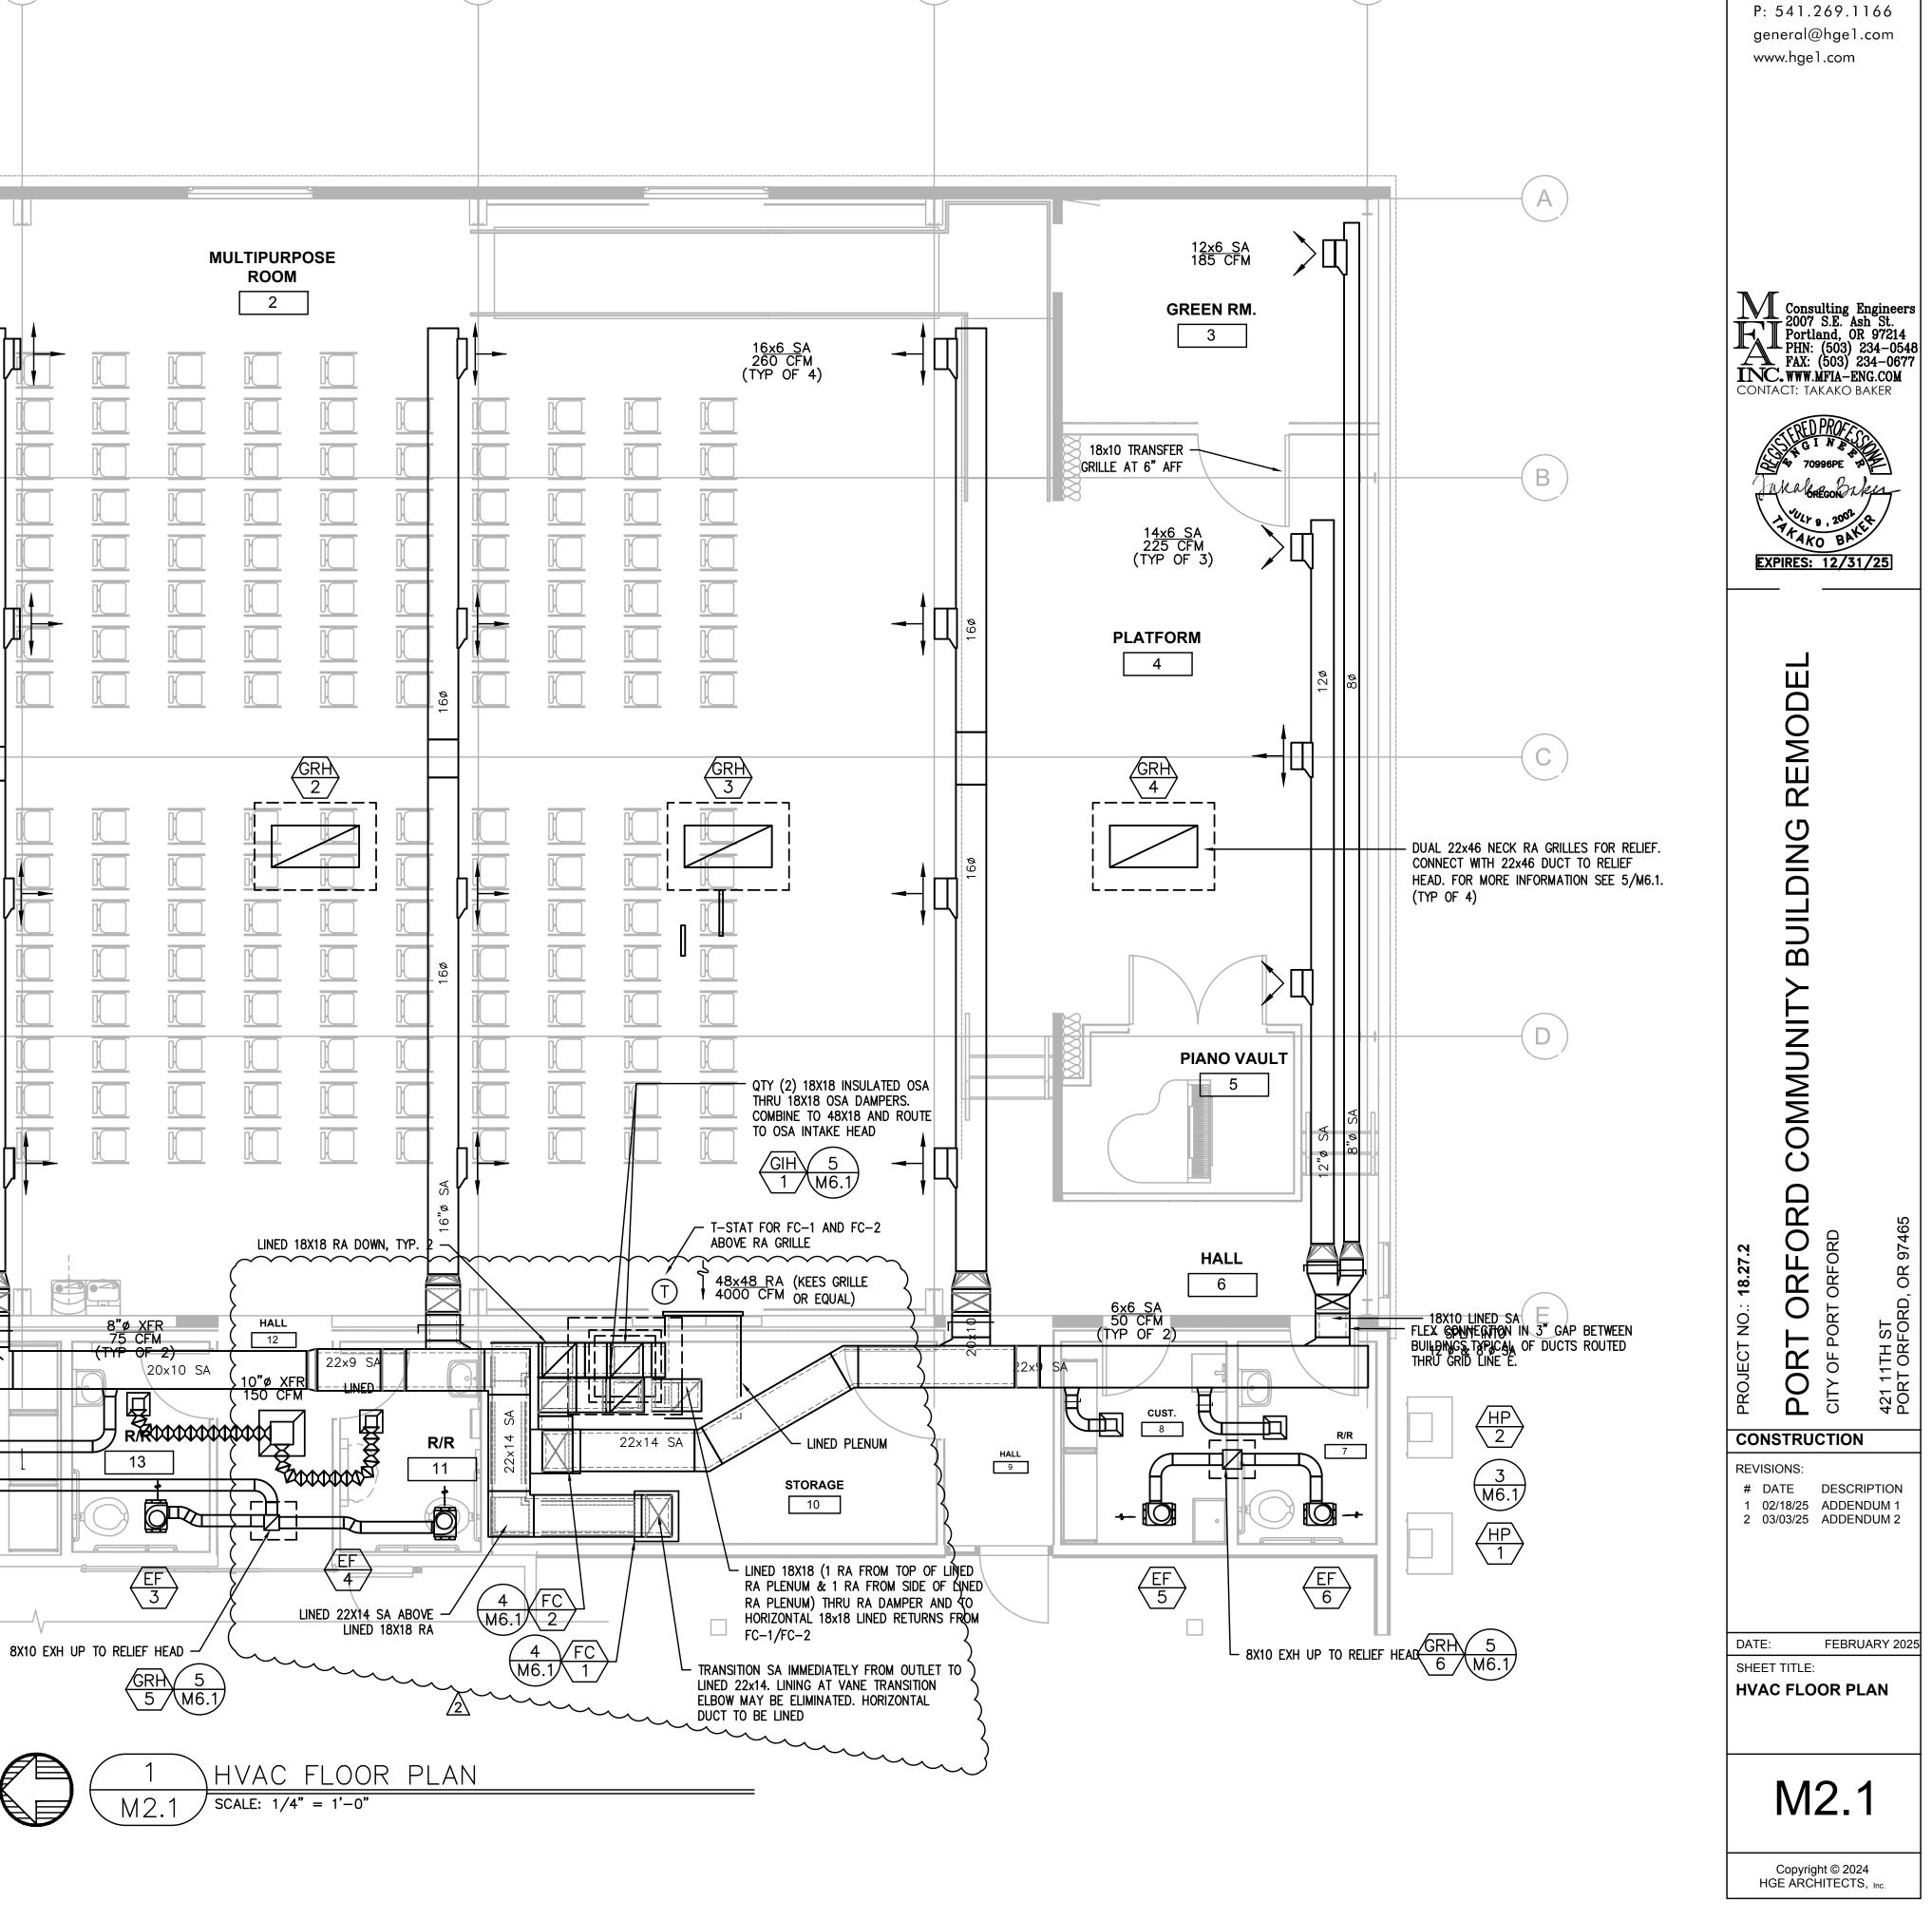

SA TO SLOPE WITH CEILING, PROVIDE FITTING AT PEAK (TYP OF 3)

18x10 DOOR TRANSFER GRILLE.

SERVICE ENTRY

15

ALL DUCTWORK EAST OF GRIDLINE 'E' IS EXPOSED BELOW THE CEILING. FOR

DUCTWORK WEST OF GRIDLINE 'E', SEE ARCHITECTURAL DRAWING WHERE

DUCTWORK IS ALLOWED TO BE EXPOSED.

TRANSITION TO 16"Ø HERE.

UP TO NEAR CEILING.

20x10 THRU WALL AND TRANSITION -

KITCHEN ST.


14

6" AFF

VEST.

TERMINATE WITH JOHNSON AIR PRODUCT F8WVA

1

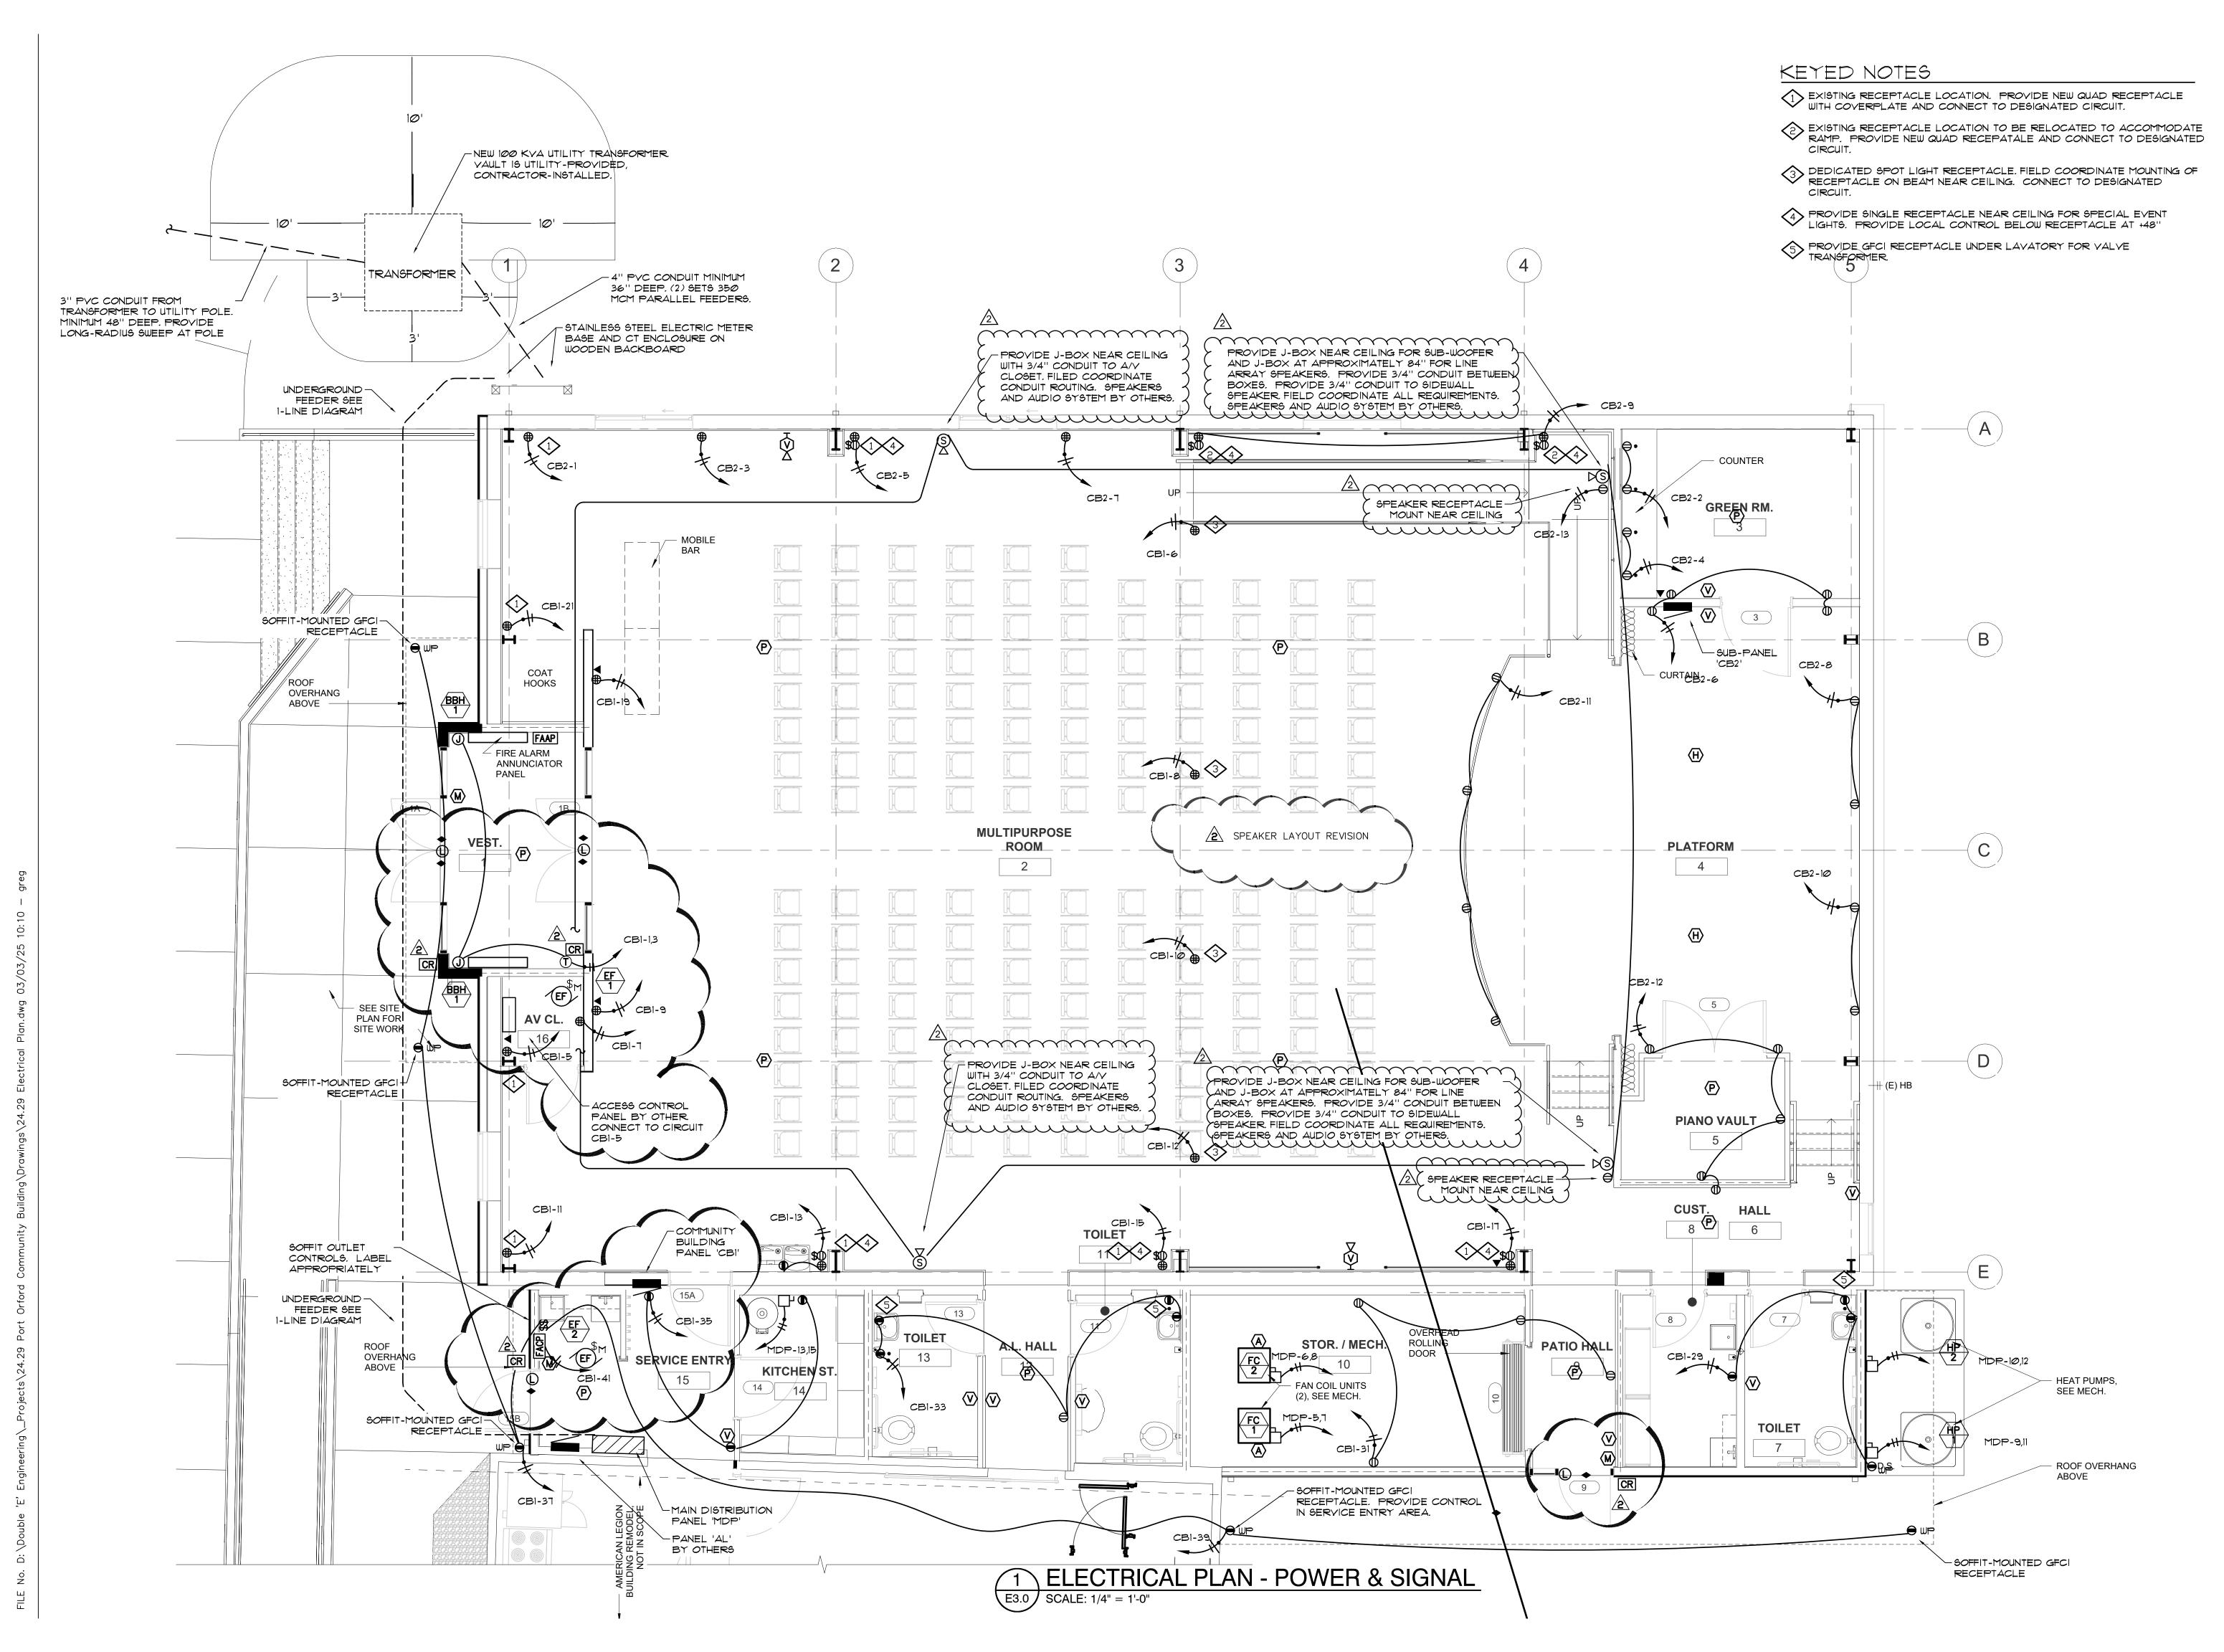




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DOUBLE 'E'
ENGINEERING, L
Myrtle Point, Oregon
www.ee-engineering.com



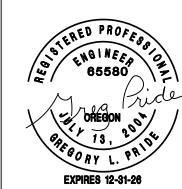

ORFORD COMMUNITY BUILDING REMODEL

PORT ORFORD CO

CONSTRUCTION

REVISIONS:

REVISIONS:
DATE DESCRIPTION
2 3/3/25 ADD No. 2

DATE: FEBRUARY 2025

SHEET TITLE:

ELECTRICAL PLANS
POWER & SIGNAL

E3.0