

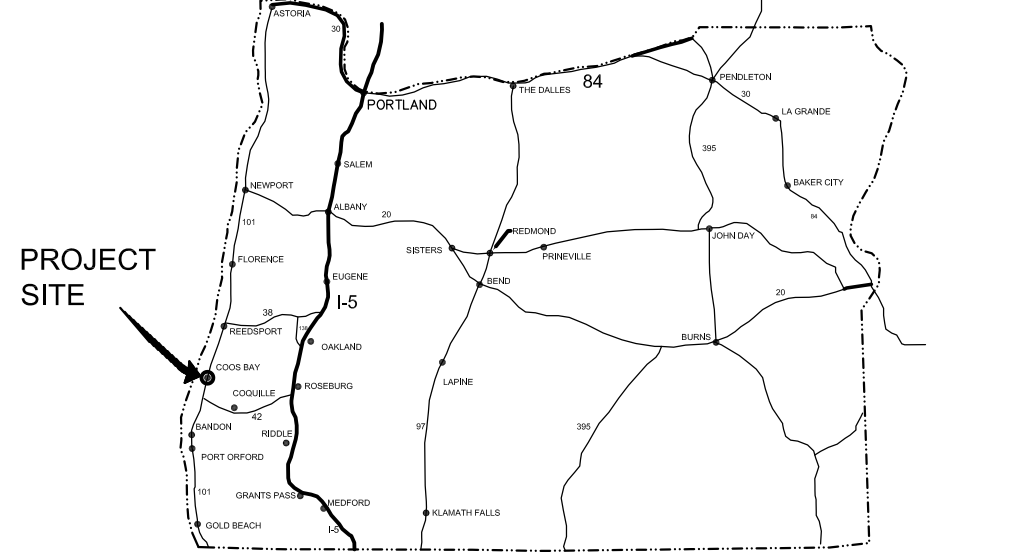


# COOS BAY SCHOOL DISTRICT MARSHFIELD HIGH SCHOOL SOFTBALL BATTLING CAGE STRUCTURE - REBID

ABBREVIATIONS	ALTERNATE BIDS	TEAM	LOCATION	SHEET INDEX
<p>(E) EXISTING EA. EACH O.C. ON CENTER GLB GLUE LAMINATED BEAM SAMF SELF ADHERING MEMBRANE FLASHING TYP. TYPICAL WRB WEATHER RESISTANT BARRIER</p>	<p>ALTERNATE BID #1 - PROVIDE OVERHEAD LIGHTING, ASSOCIATED CONDUIT AND WIRING IN OPEN AIR BATTLING CAGE AREA 01. PROVIDE JUNCTION BOX FOR FUTURE LIGHT SWITCHES WITH BLANK COVER. PROVIDE CONDUIT FROM JUNCTION BOX UP THROUGH WALL INTO ATTIC SPACE ABOVE TEAM ROOM 02 FOR FUTURE INSTALLATION OF WIRING FOR LIGHTS.</p> <p>ALTERNATE BID #2 - PROVIDE TRANSLUCENT "SKYLIGHT" ROOF PANELS IN METAL ROOFING</p> <p>ALTERNATE BID #3 - PROVIDE SINGLE GLAZED, TEMPERED, FIXED VINYL WINDOWS IN UPPER PORTION OF EXTERIOR WALL AT BATTLING CAGE AREA 01. INSTALL WELDED WIRE SCREEN ON FACE OF INTERIOR FRAMING TO PROTECT WINDOWS FROM IMPACT.</p>	<p><b>OWNER</b> COOS BAY SCHOOL DISTRICT #9 1225 HEMLOCK AVE. COOS BAY, OR 97420</p> <p><b>ARCHITECT</b> HGE ARCHITECTS Inc. 333 S. 4TH STREET, COOS BAY, OREGON 97420 PHONE: 541.269.1166 FAX: 541.269.1833 CONTACT - ANDREW J. LOCATI, AIA</p> <p><b>STRUCTURAL ENGINEER</b> REBAI TAMEROULET S &amp; T CONSULTING ENGINEERS 6635 SKYLINE ROAD S. SALEM, OR 97306 503-931-2767</p> <p><b>ELECTRICAL ENGINEER</b> GREG PRIDE DOUBLE 'E' ENGINEERING LLC 315 ASH STREET MYRTLE POINT, OR 97458 541-294-0587</p>	 <p>PROJECT SITE: SOUTH COAST EDUCATION SERVICE DISTRICT FIELD 1400 TEAKWOOD AVE, COOS BAY, OR 97420</p>	<p><b>ARCHITECTURAL</b> A1.0 COVER SHEET, SHEET INDEX, OVERALL SITE PLAN, VICINITY MAP A1.1 SITE PLAN, SURVEY A2.1 FLOOR PLAN, ROOF PLAN A4.1 SECTIONS, DETAILS A3.1 EXTERIOR ELEVATIONS, DETAILS</p> <p><b>STRUCTURAL</b> S0.0 GENERAL NOTES S1.0 PLANS - FOUNDATION, ROOF S2.0 SECTIONS AND DETAILS S3.0 DETAILS</p> <p><b>ELECTRICAL</b> E1 ELECTRICAL PLAN, POWER AND LIGHTING, PANEL</p>

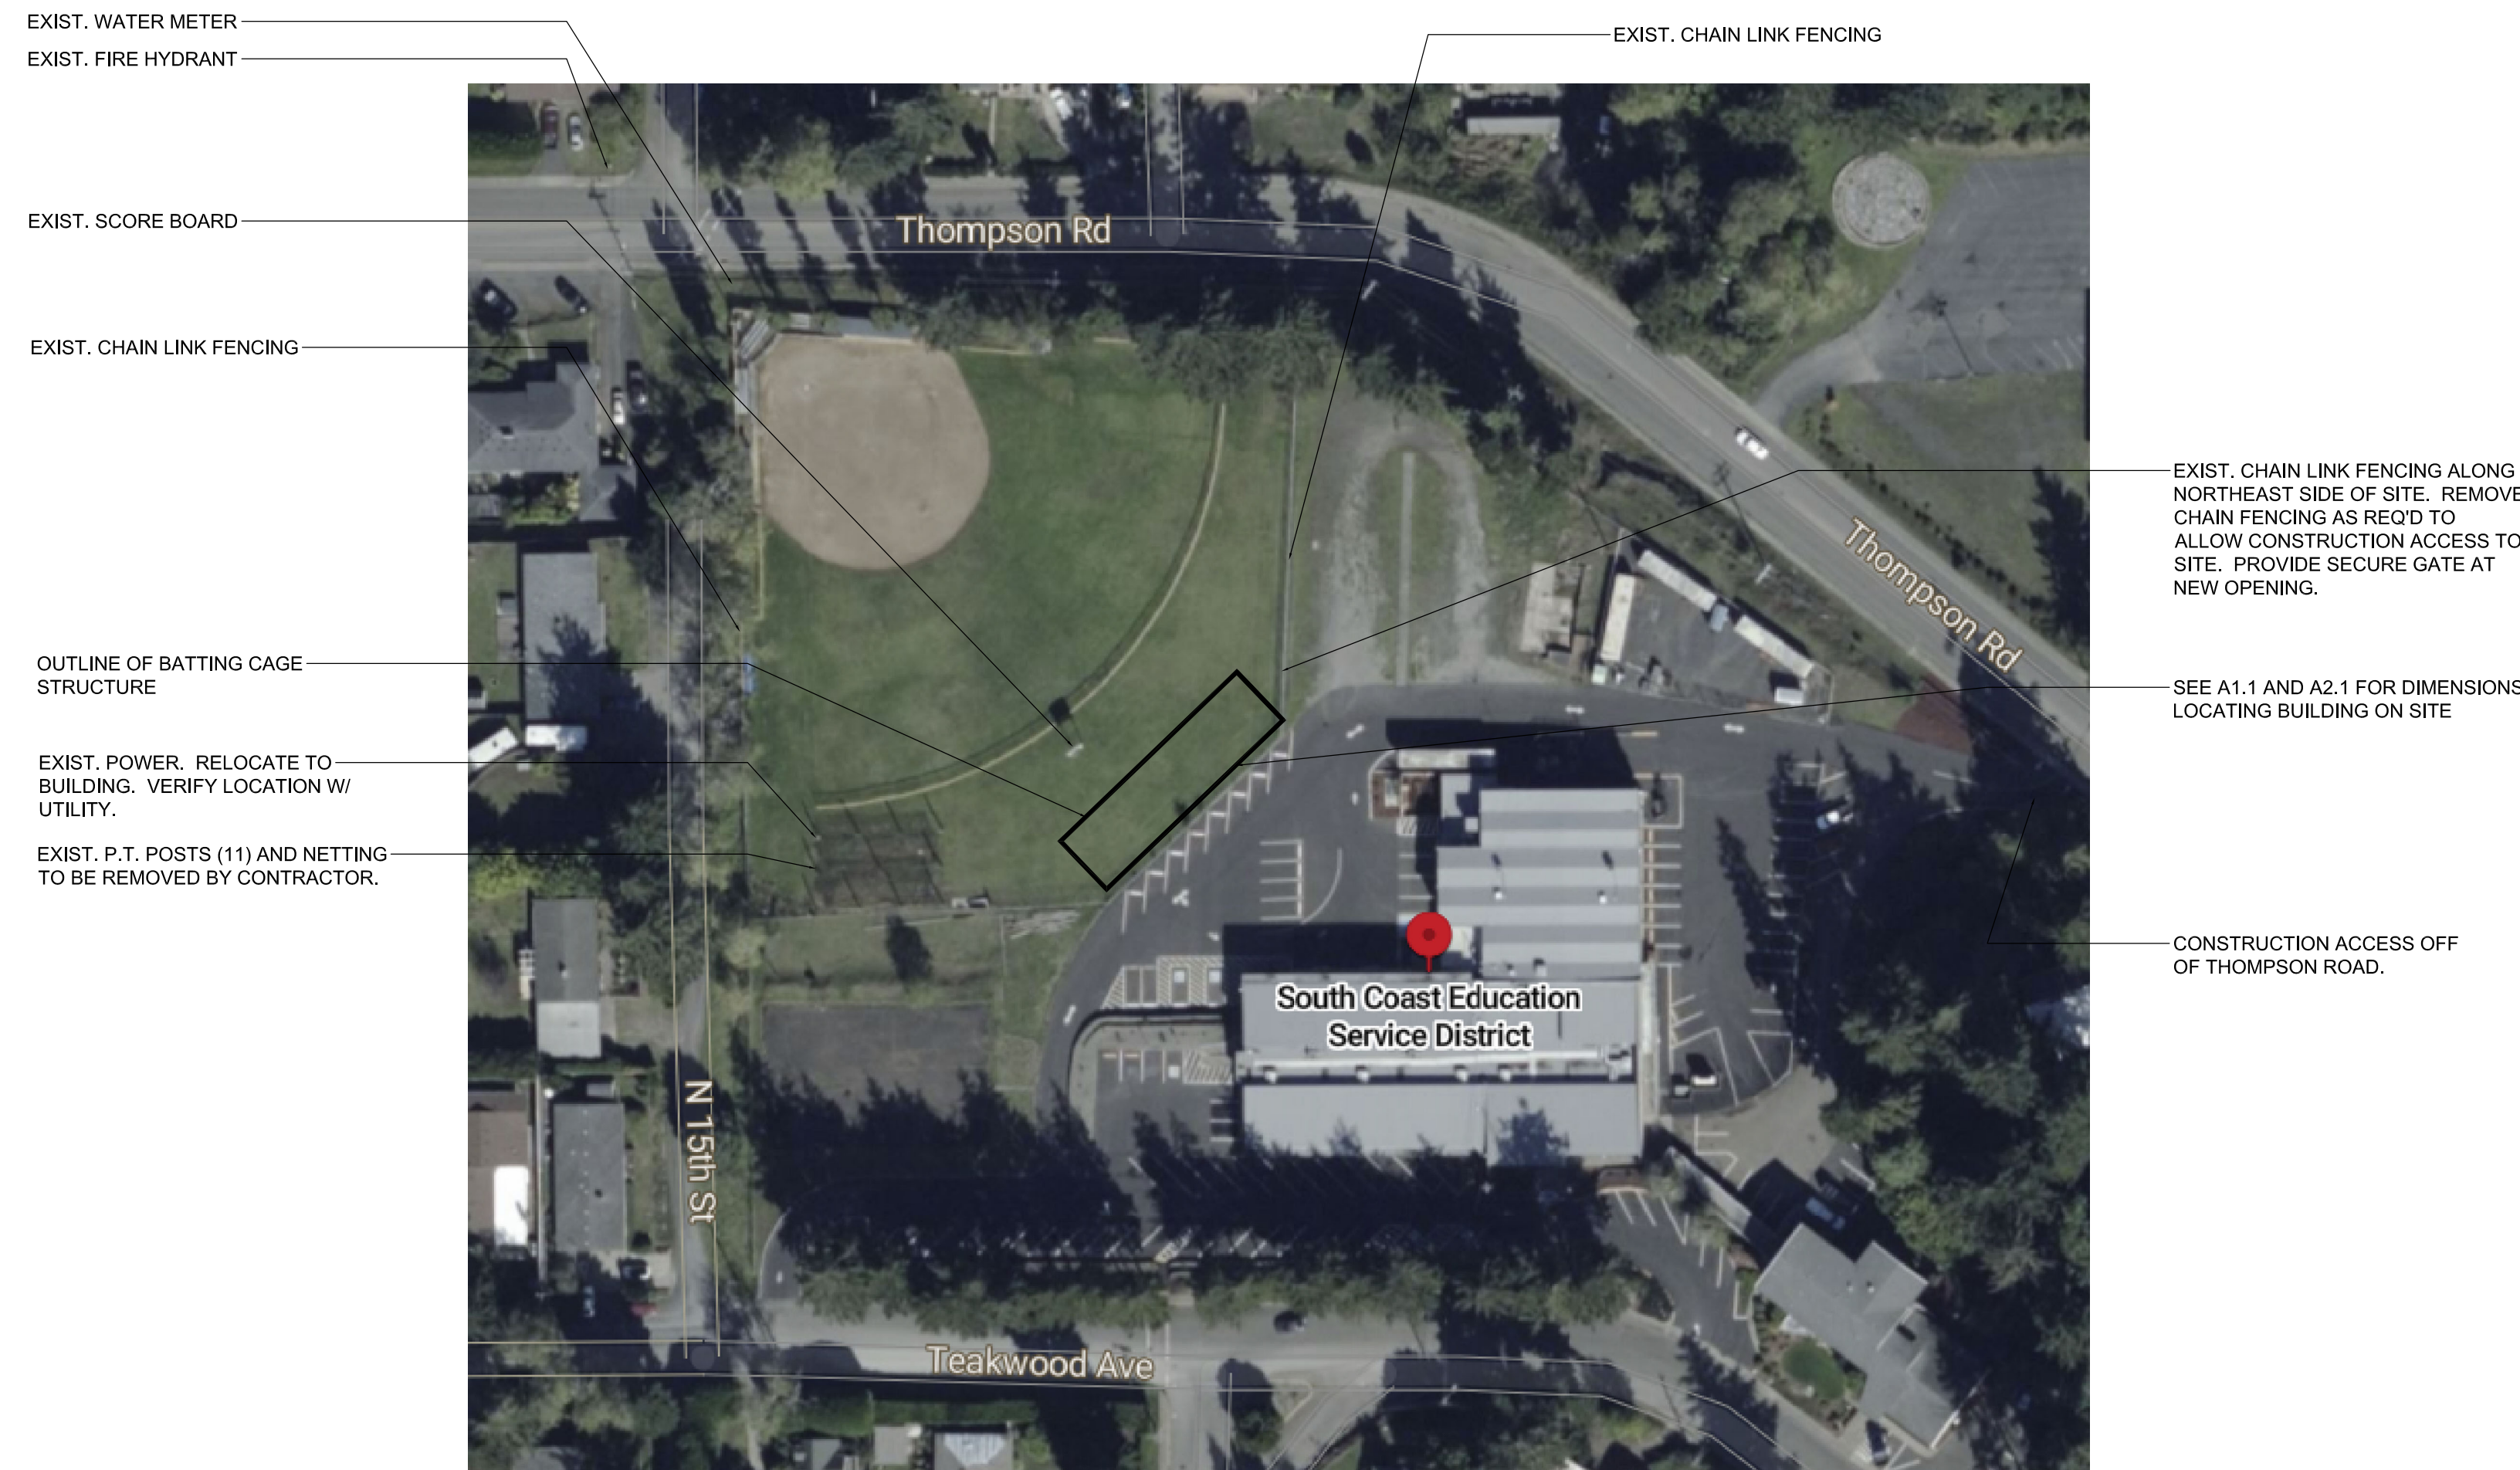

1 SITE PLAN  
A1.0 SCALE: NONE

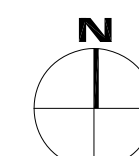


PROJECT NO.: 22.48  
**MHS SOFTBALL BATTLING CAGE STRUCTURE - REBID**  
 SOUTH COAST EDUCATION SERVICE DISTRICT FIELD  
 1400 TEAKWOOD AVE.  
 COOS BAY, OR 97420

CONSTRUCTION		
REVISIONS:	#	DATE DESCRIPTION

DATE: OCTOBER 2023

SHEET TITLE:  
**OVERALL SITE PLAN  
SHEET INDEX  
VICINITY MAP**

**A1.0**

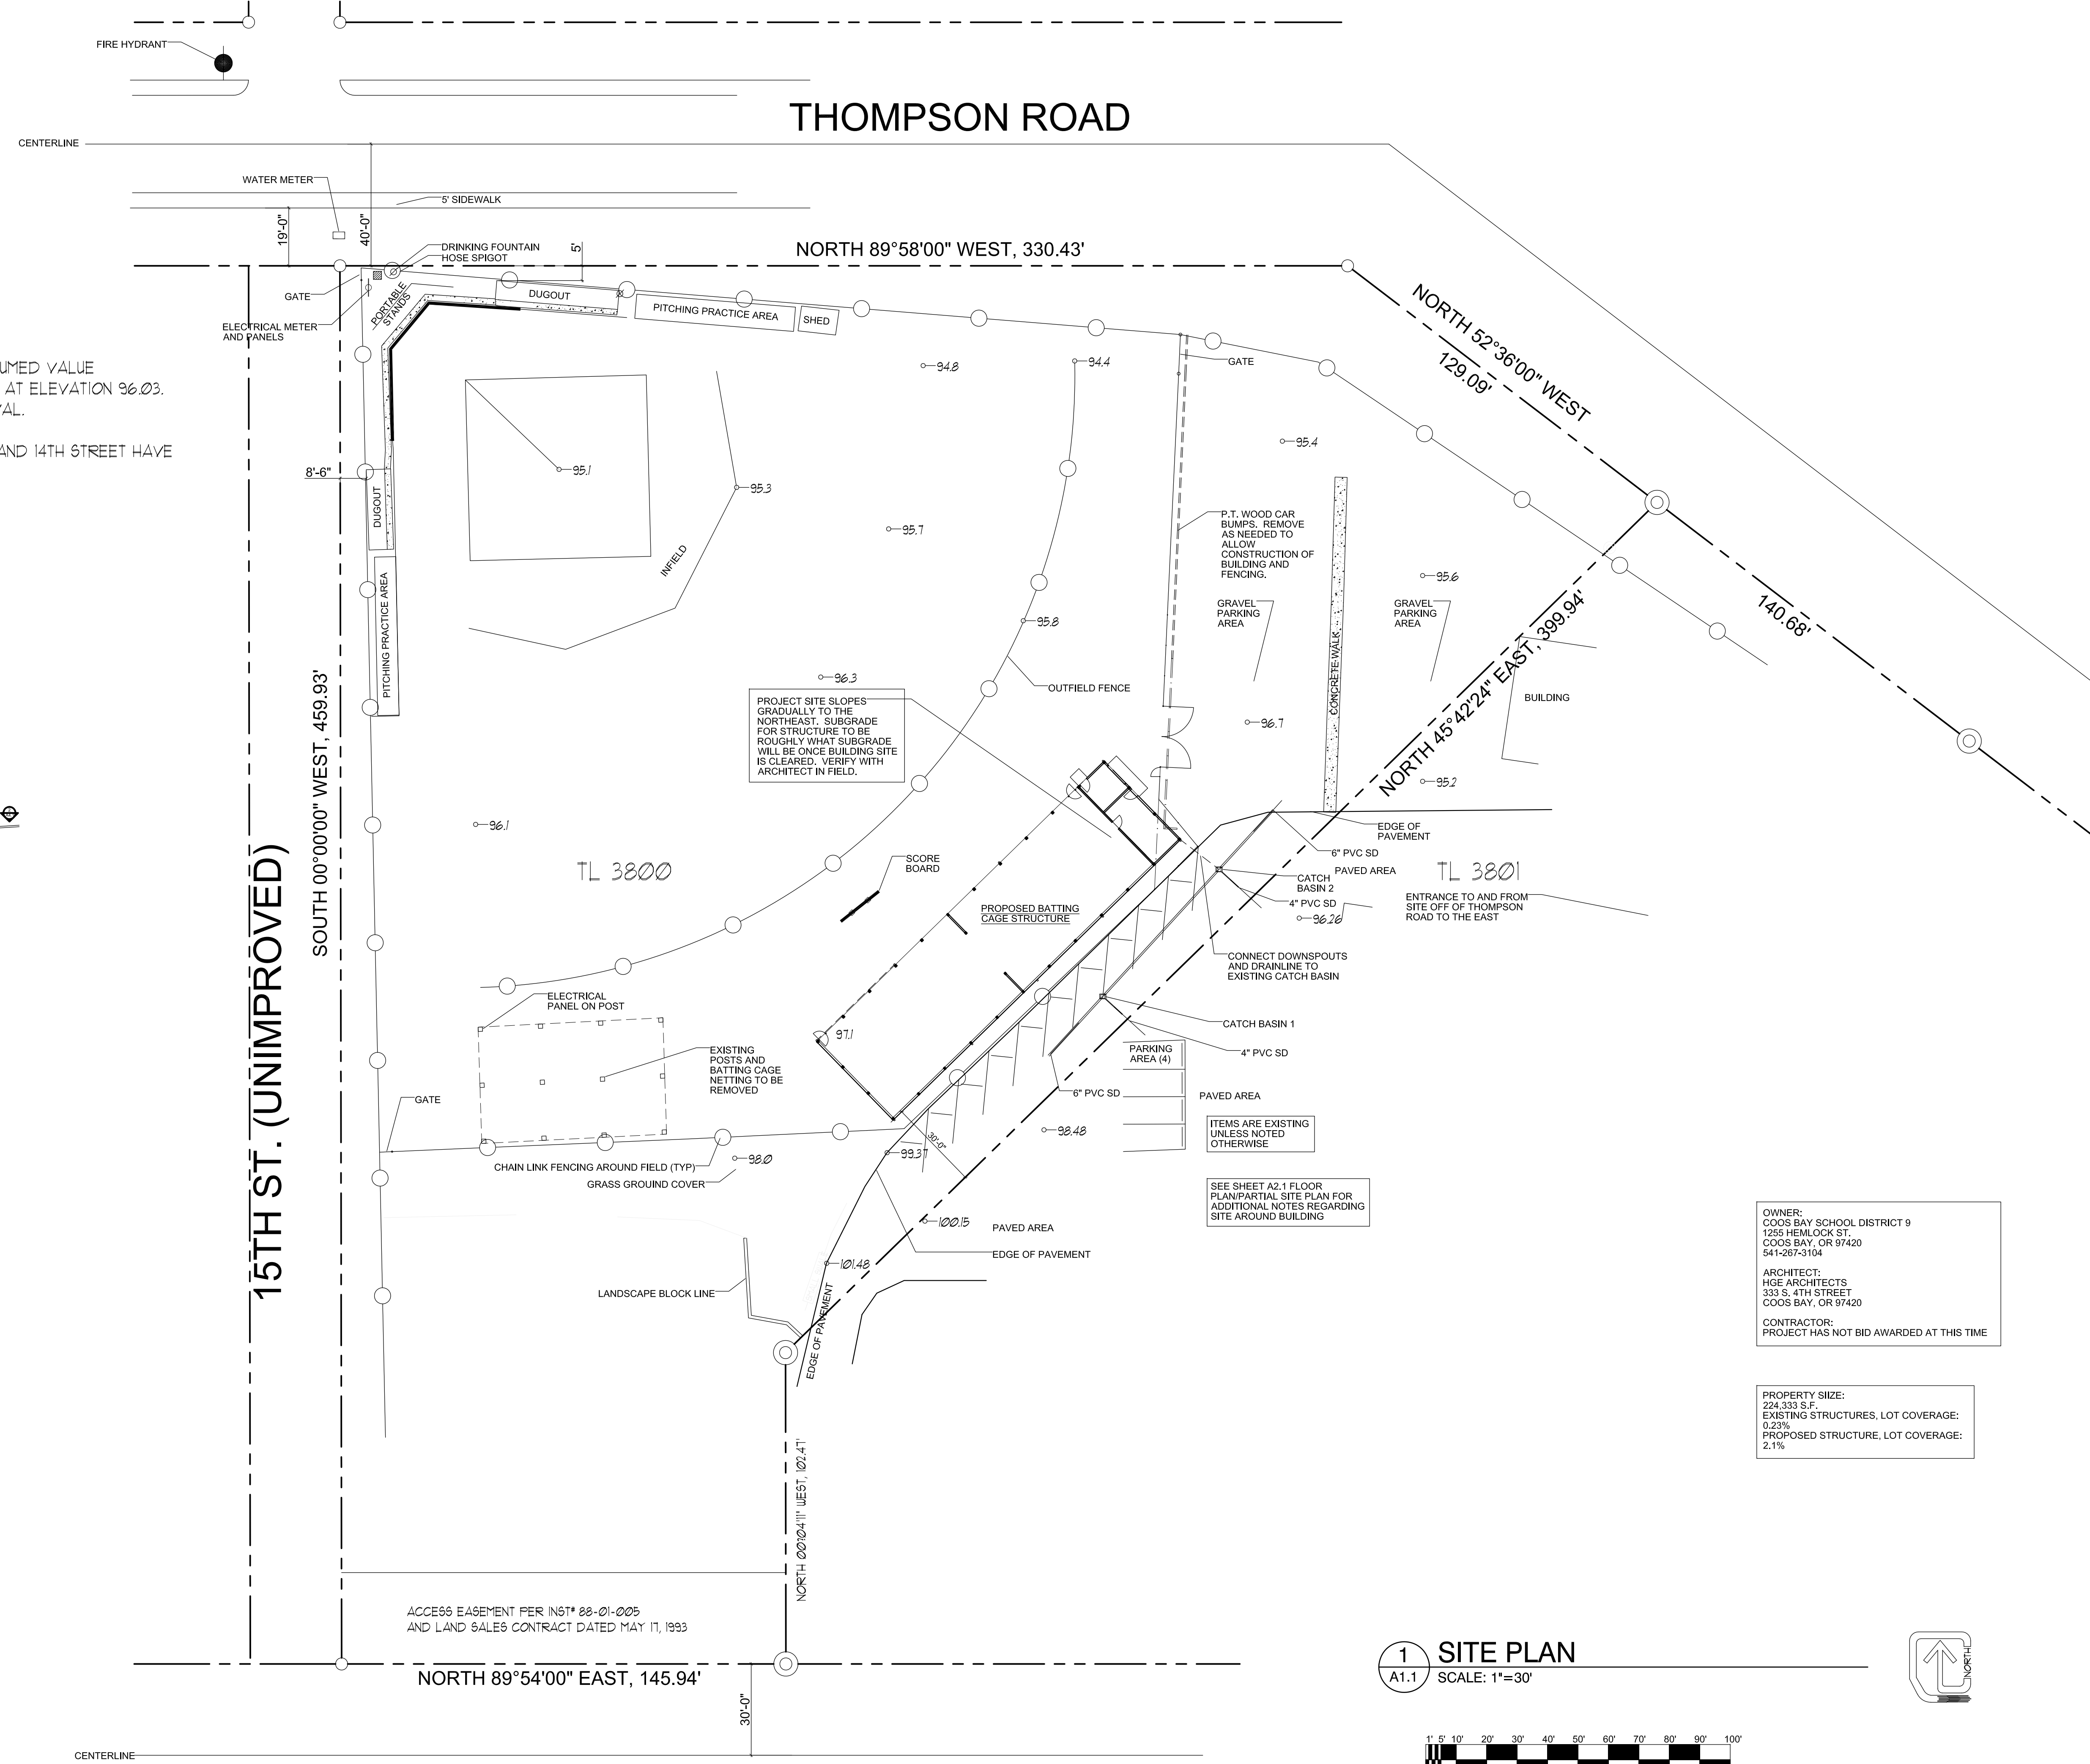

**NOTES:**

- 1.) ALL ELEVATIONS SHOWN HAVE BEEN BASED ON AN ASSUMED VALUE CTRL POINT #1 IS AT ELEVATION 100.00 / CTRL POINT #2 IS AT ELEVATION 96.03.
- 2.) CONTOURS HAVE BEEN SHOWN AT A 1' VERTICAL INTERVAL.
- 3.) THE BOUNDARY IS PER PARTITION PLAT 2012 #06.
- 4.) VACATED PORTIONS OF BOULEVARD PARK ADDITION AND 14TH STREET HAVE NOT BEEN SHOWN FOR MAPPING CLARITY.

**OWNERSHIP INFO:**


OWNER: SCHOOL DISTRICT #9  
TAX ACCOUNT # 64350.01  
TAX MAP 25 13 22 DB / TAX LOT 3800  
DEED REFERENCE: 13-90905  
ZONING DESIGNATION: GP 3

OWNER: SOUTH COAST EDUCATION  
TAX ACCOUNT # 64350.05  
TAX MAP 25 13 22 DB / TAX LOT 3801  
DEED REFERENCE: 88-01-0056  
ZONING DESIGNATION: GP 3

**SYMBOL LEGEND**

- ← TRAFFIC DIRECTIONAL ARROW
- CALCULATED POSITION
- ♿ HANDICAPPED PARKING
- LA LANDSCAPED AREA
- METER BOX / CTRL BOX
- ⊗ WATER HOSE BIB CONNECTION
- WATER FOUNTAIN
- ⊗ FIRE HYDRANT / WV
- XXXX SPOT ELEVATION
- ⊕ UTILITY POWER POLE/ W/PANEL
- TELE PEDESTAL
- POWER VLT
- ⊕ SIGN POST
- ⊙ STREET LIGHT
- ⊙ SURVEY MONUMENT
- ☼ TREE
- CATCH BASIN
- ⊕ AREA DRAIN
- MANHOLE
- ⊕ BORING LOCATIONS (X)

**1 SITE PLAN**  
A1.1 SCALE: 1"=30'

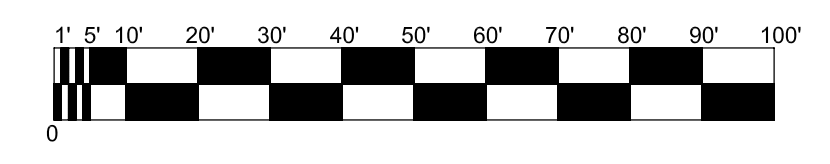




**CONSTRUCTION**

REVISIONS:	#	DATE	DESCRIPTION


DATE: OCTOBER 2023  
SHEET TITLE:

**SECTIONS  
DETAILS**


**A3.1**

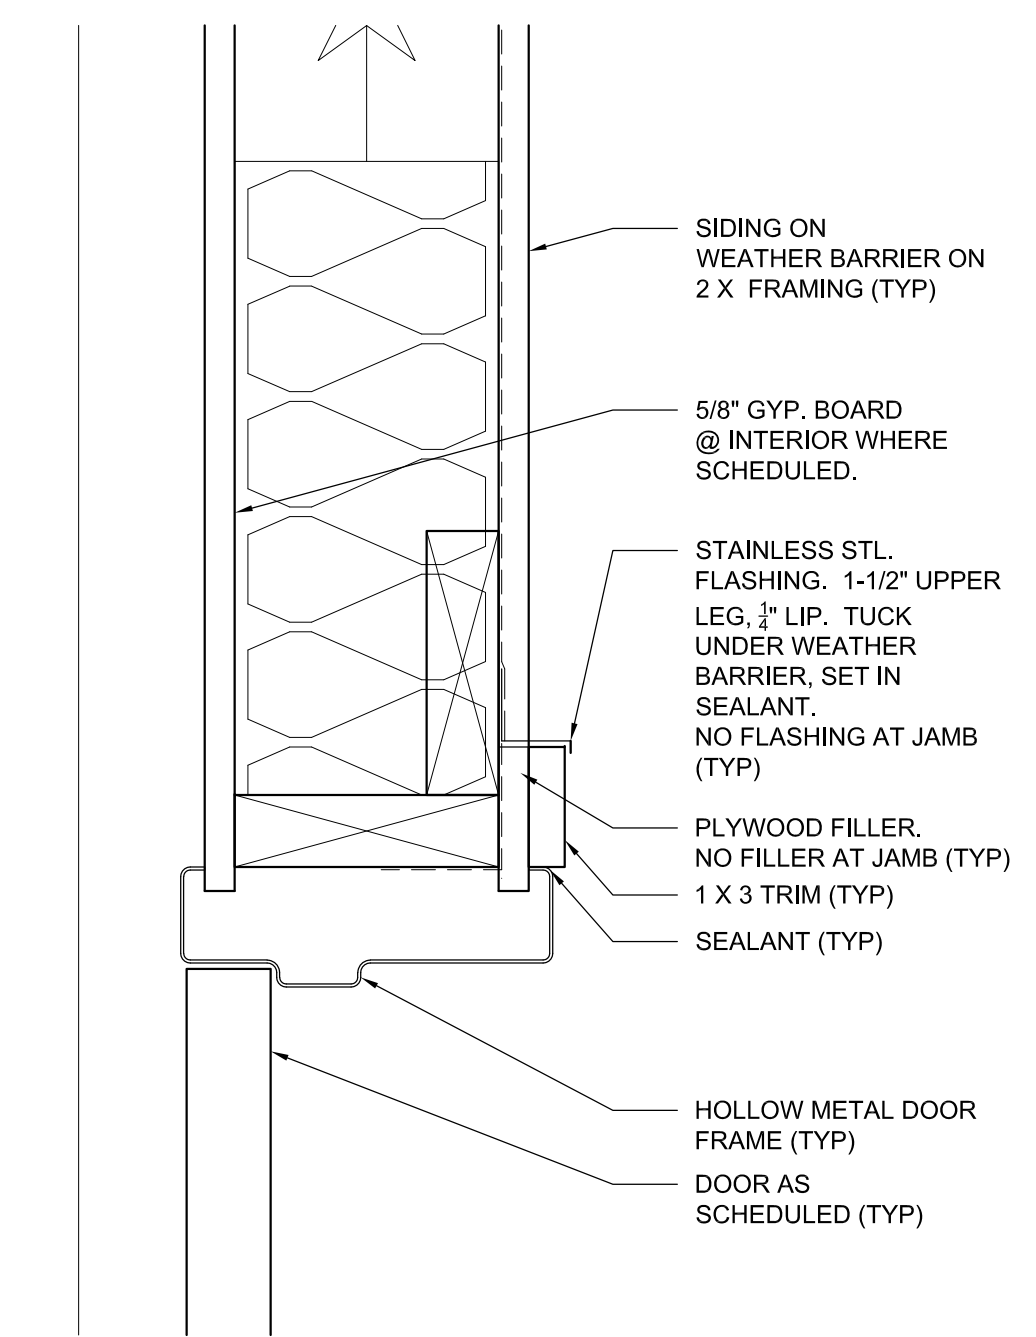


**6 H.M. HEAD - JAMB SIM.**  
A3.1 SCALE: 3" = 1'-0"

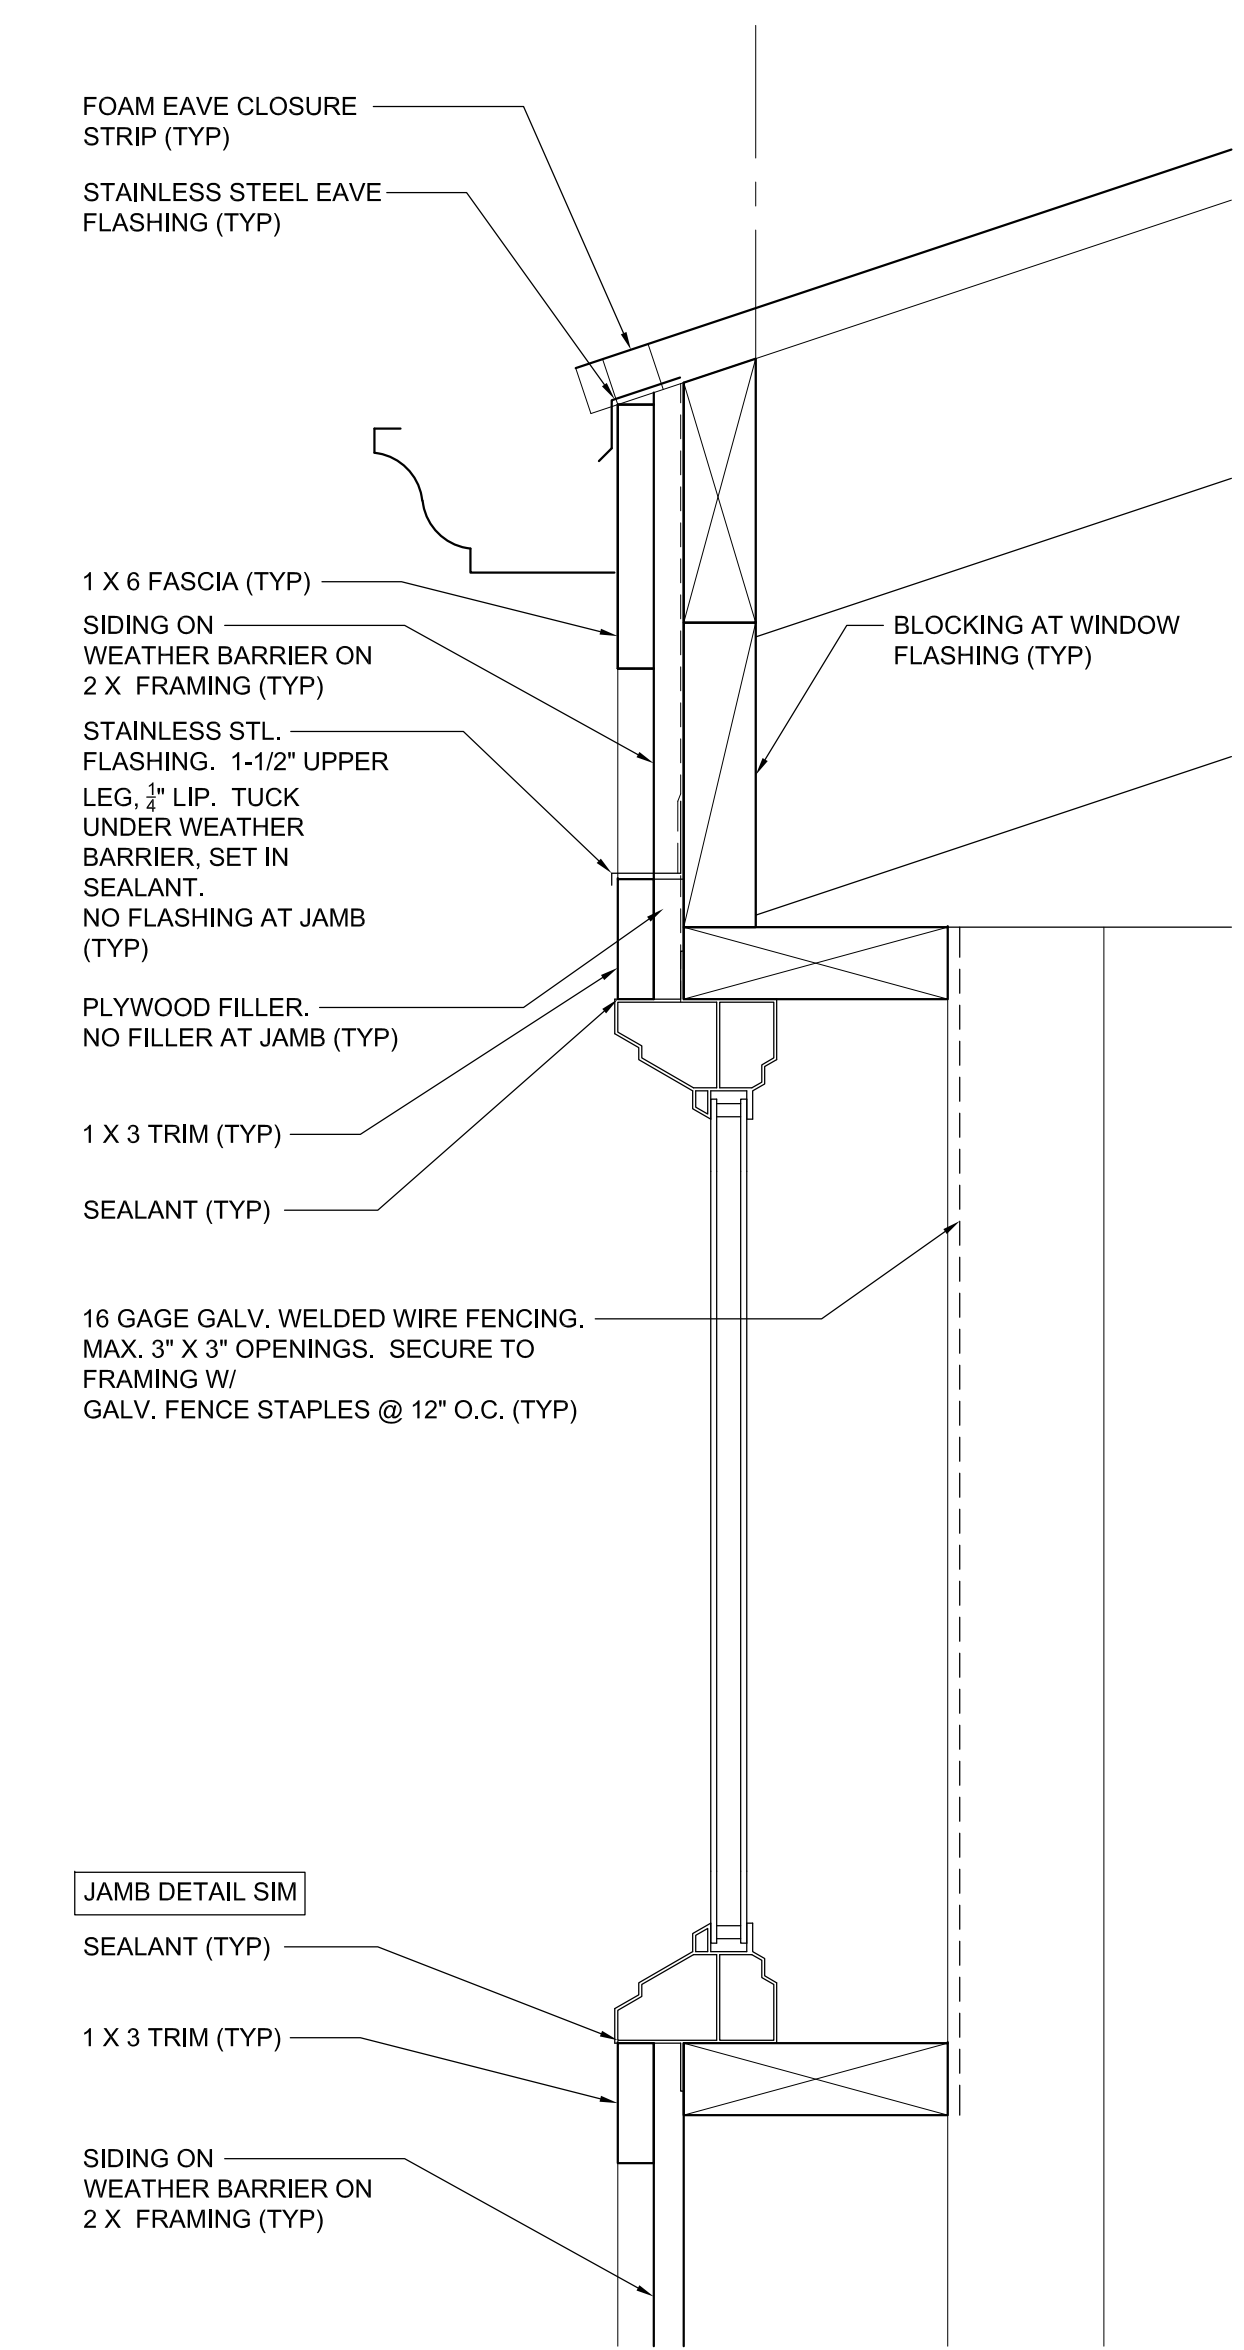


**5 FASCIA / WINDOW DETAIL**  
A3.1 SCALE: 3" = 1'-0"

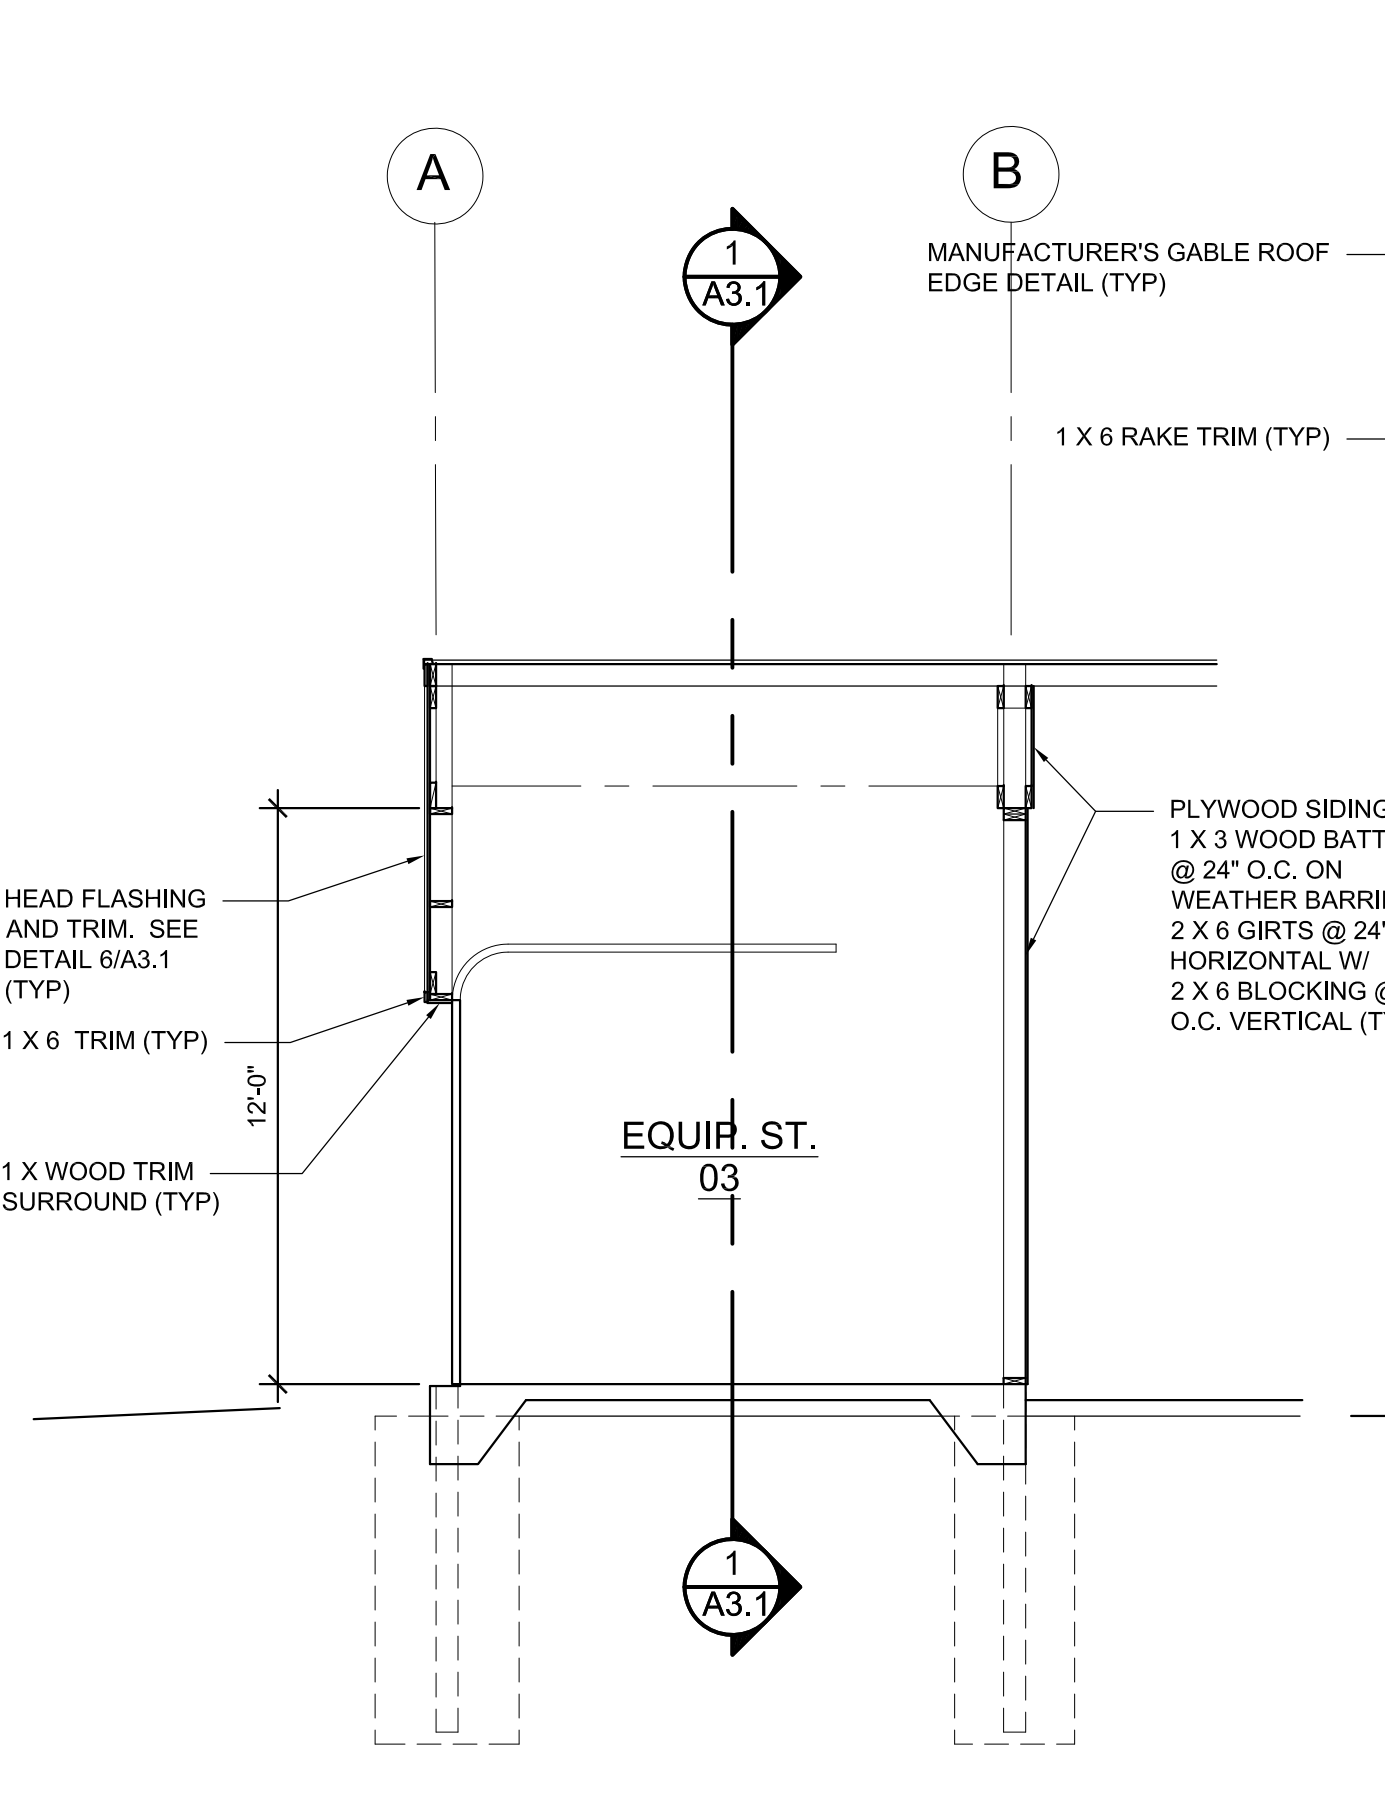


**4 SECTION**  
A3.1 SCALE: 1/4" = 1'-0"

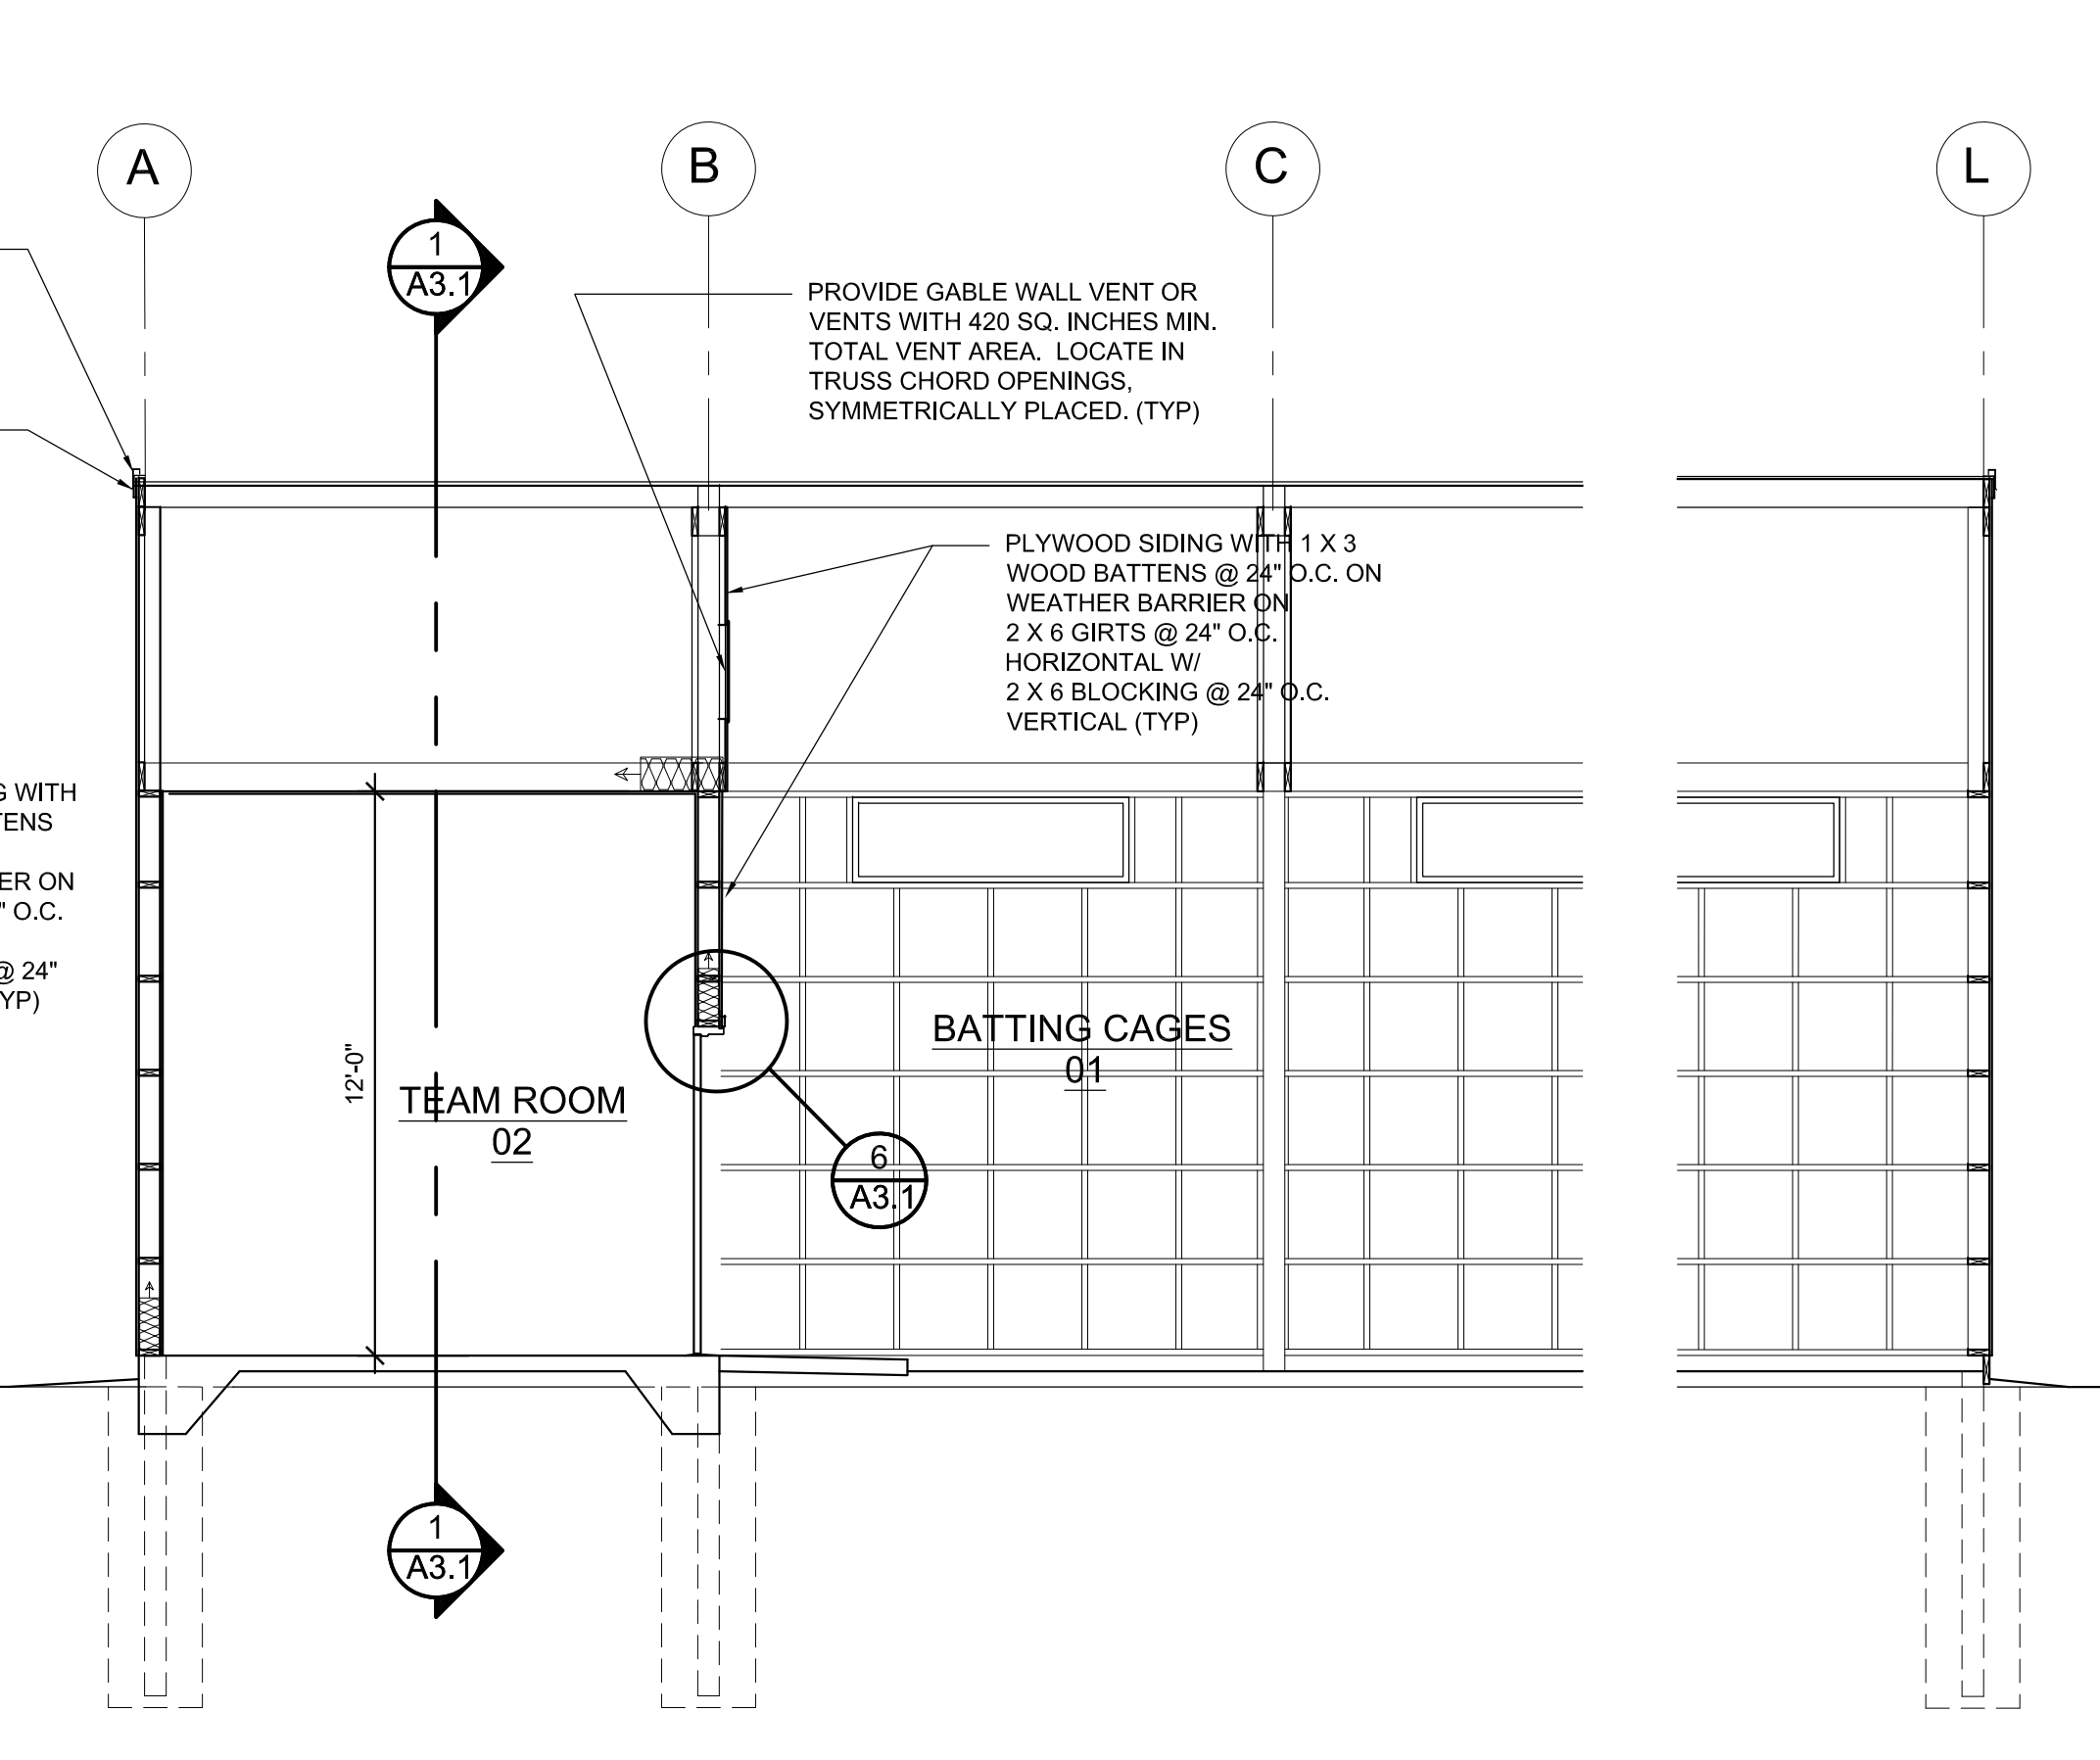

**3 SECTION**  
A3.1 SCALE: 1/4" = 1'-0"

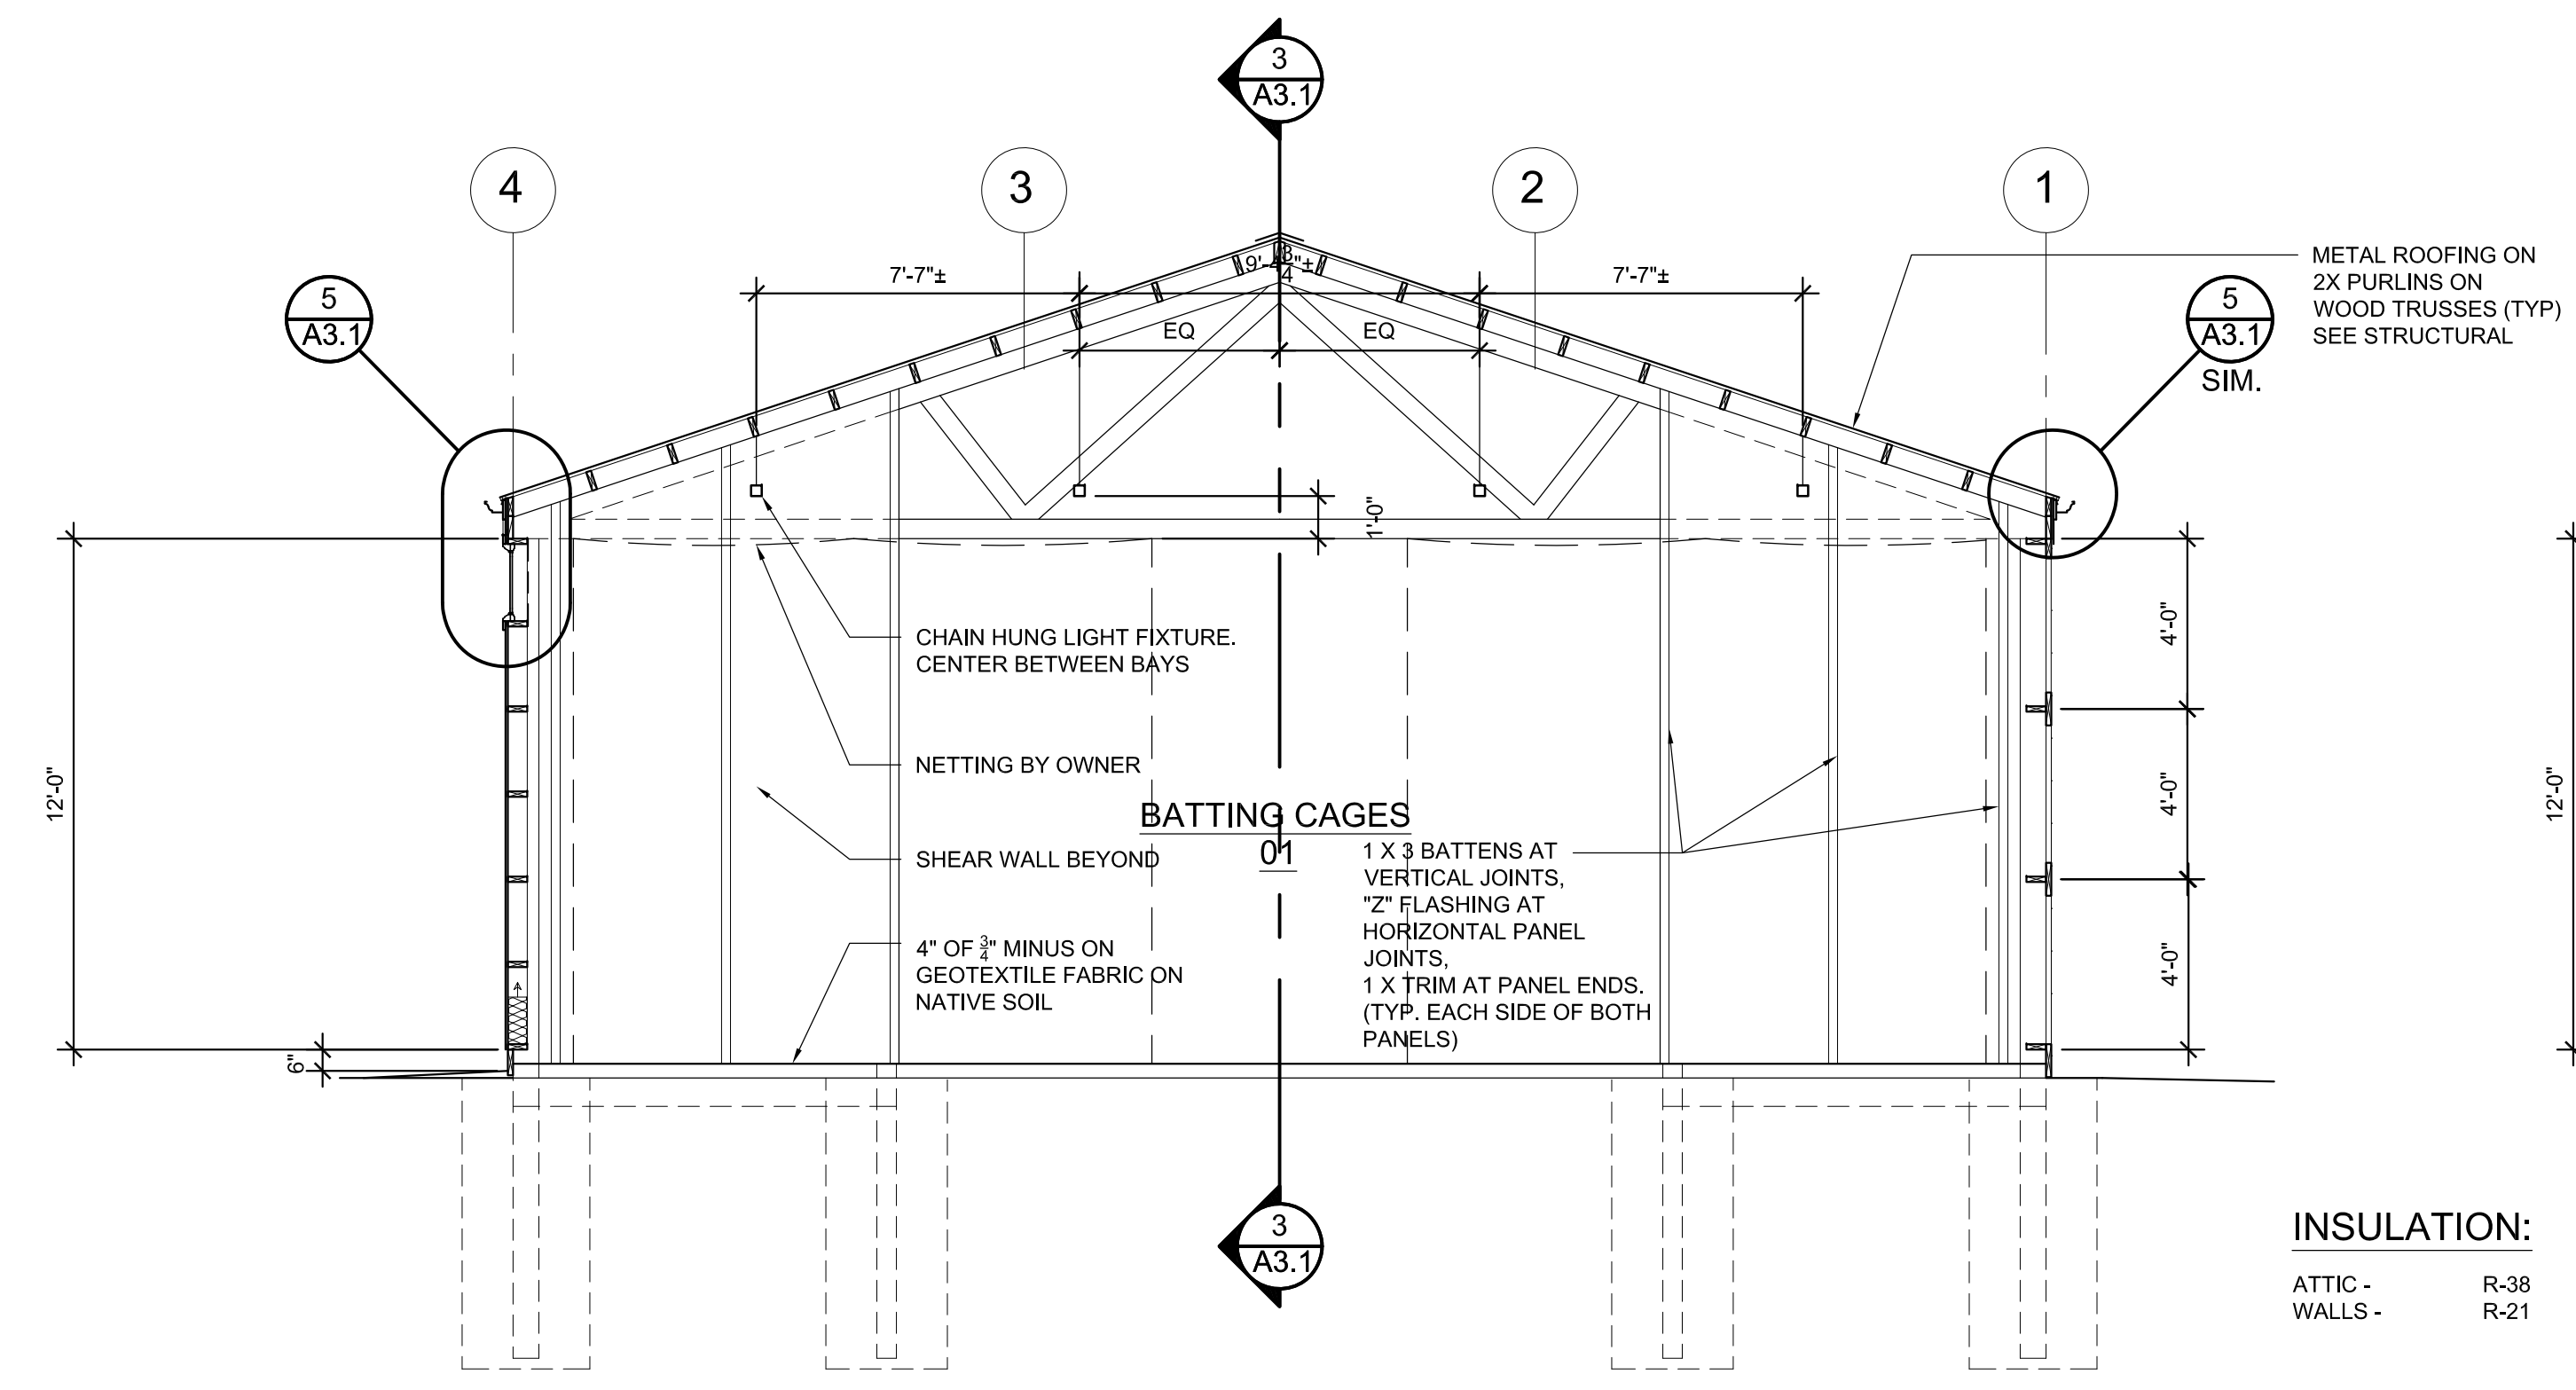

**2 SECTION**  
A3.1 SCALE: 1/4" = 1'-0"

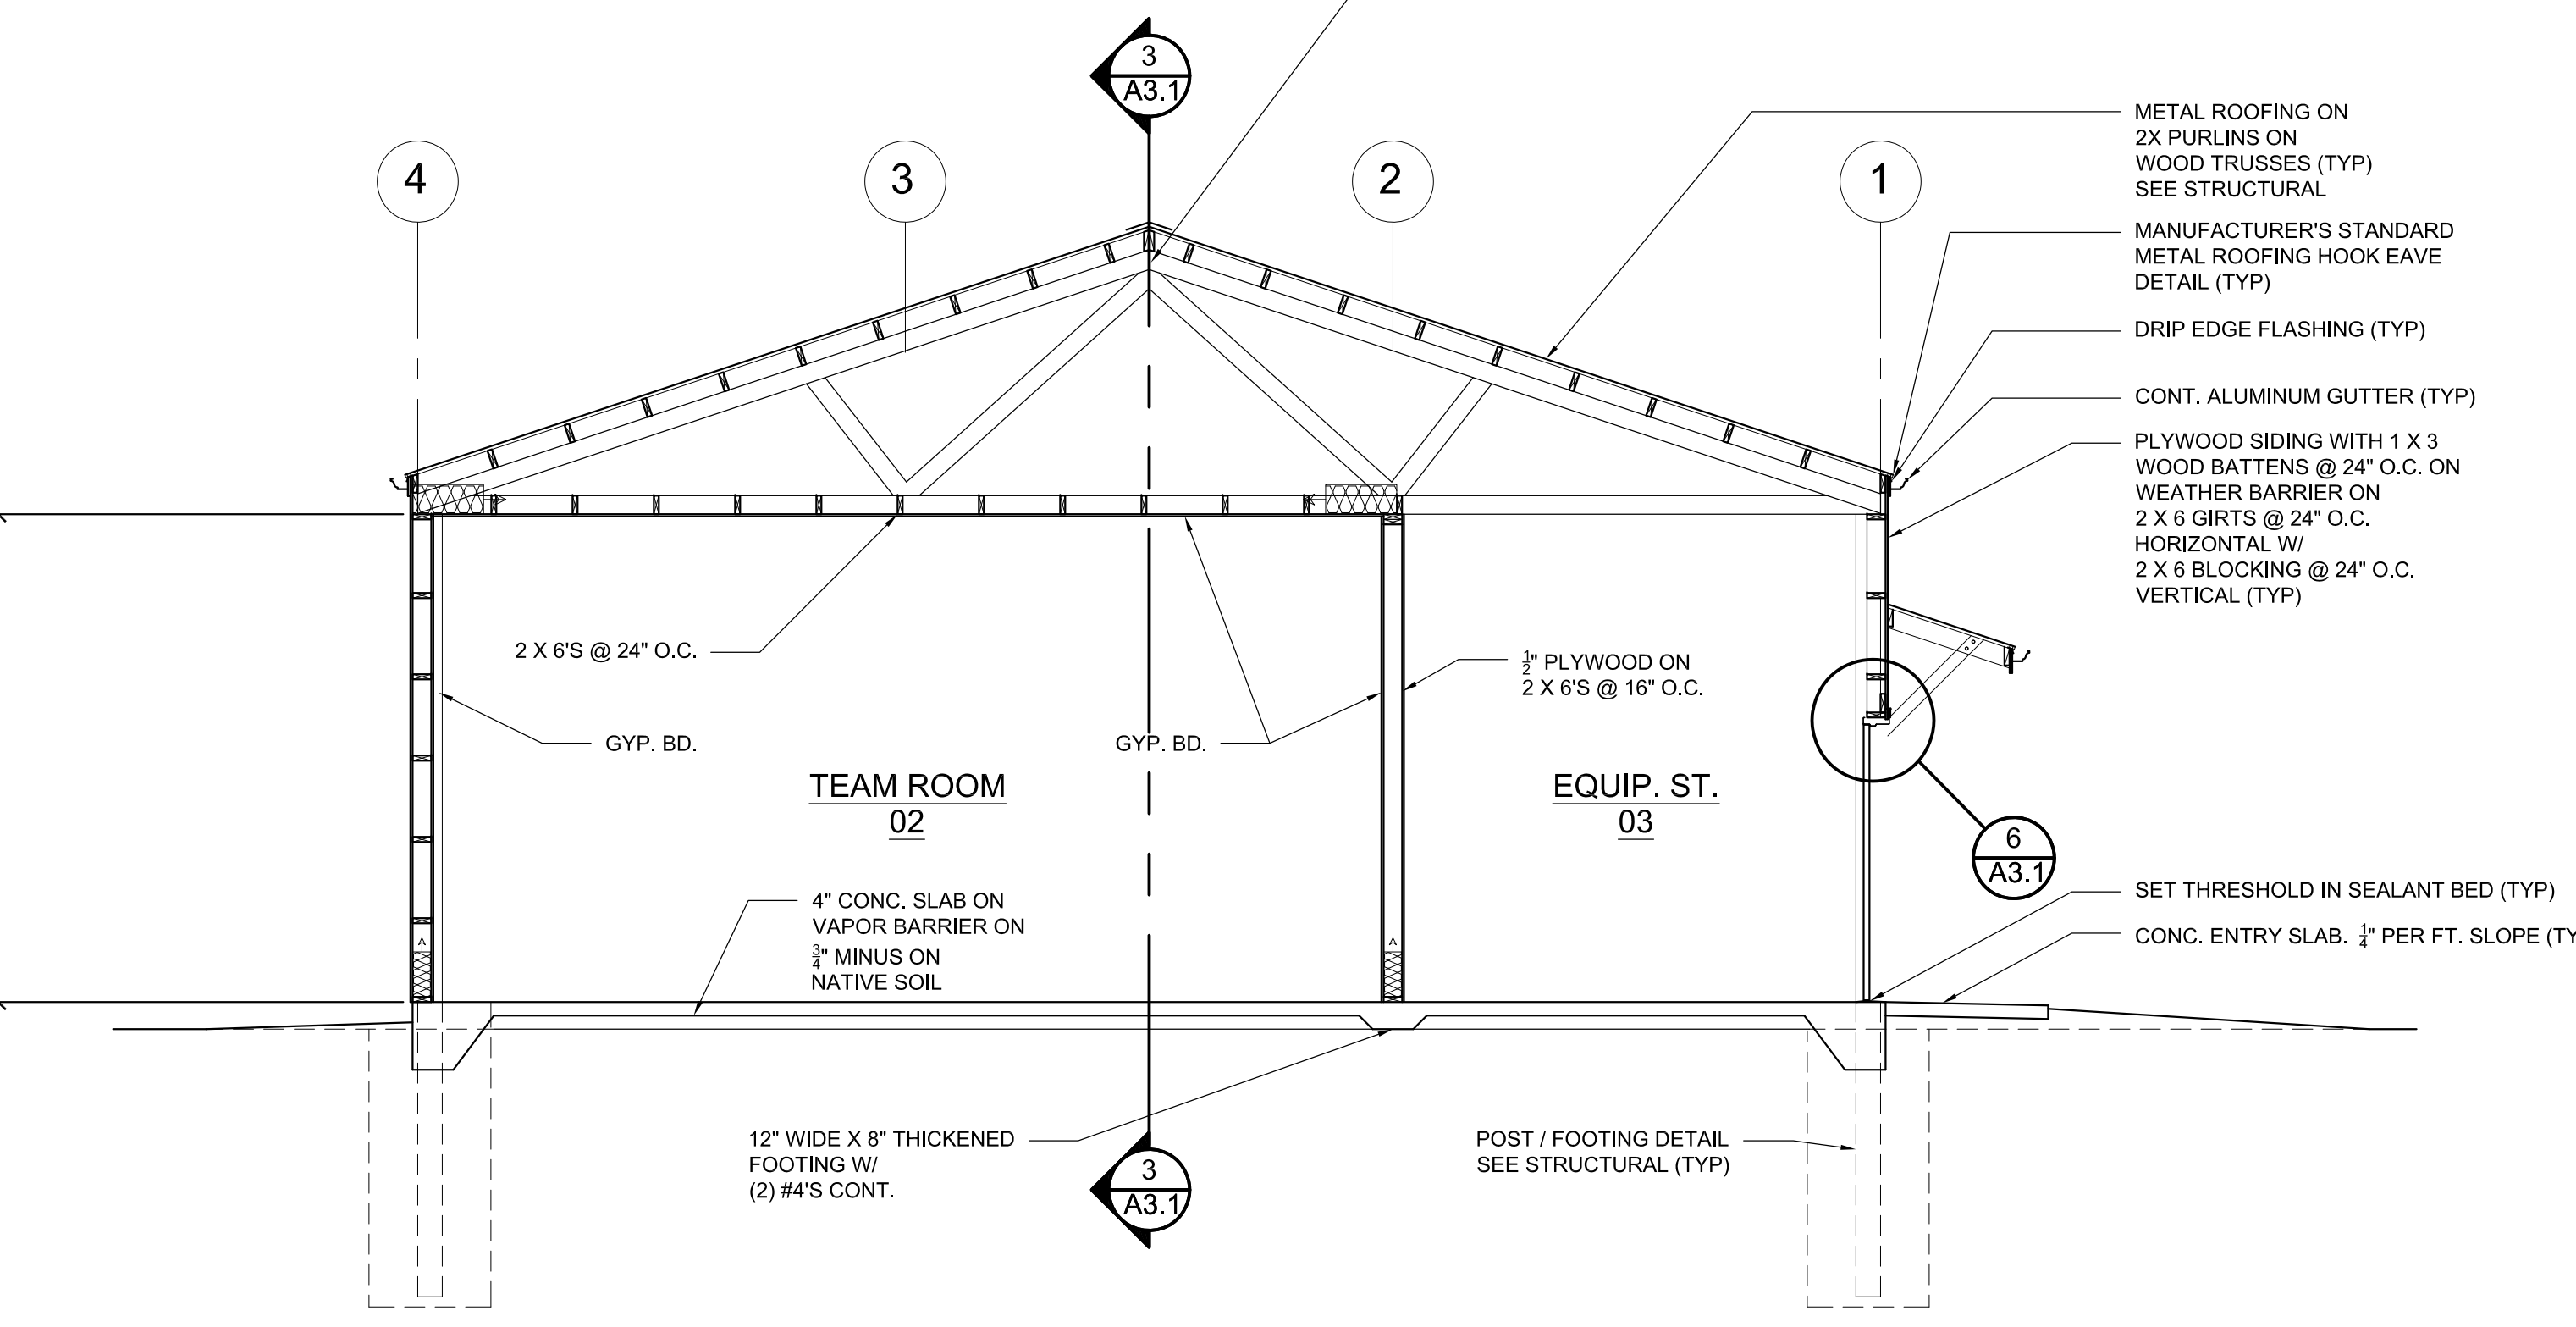

**1 SECTION**  
A3.1 SCALE: 1/4" = 1'-0"

**INSULATION:**  
ATTIC - R-38  
WALLS - R-21

**CONSTRUCTION**

REVISIONS:


#	DATE	DESCRIPTION

DATE: OCTOBER 2023


SHEET TITLE:

**ELEVATIONS  
DETAILS**


**A4.1**

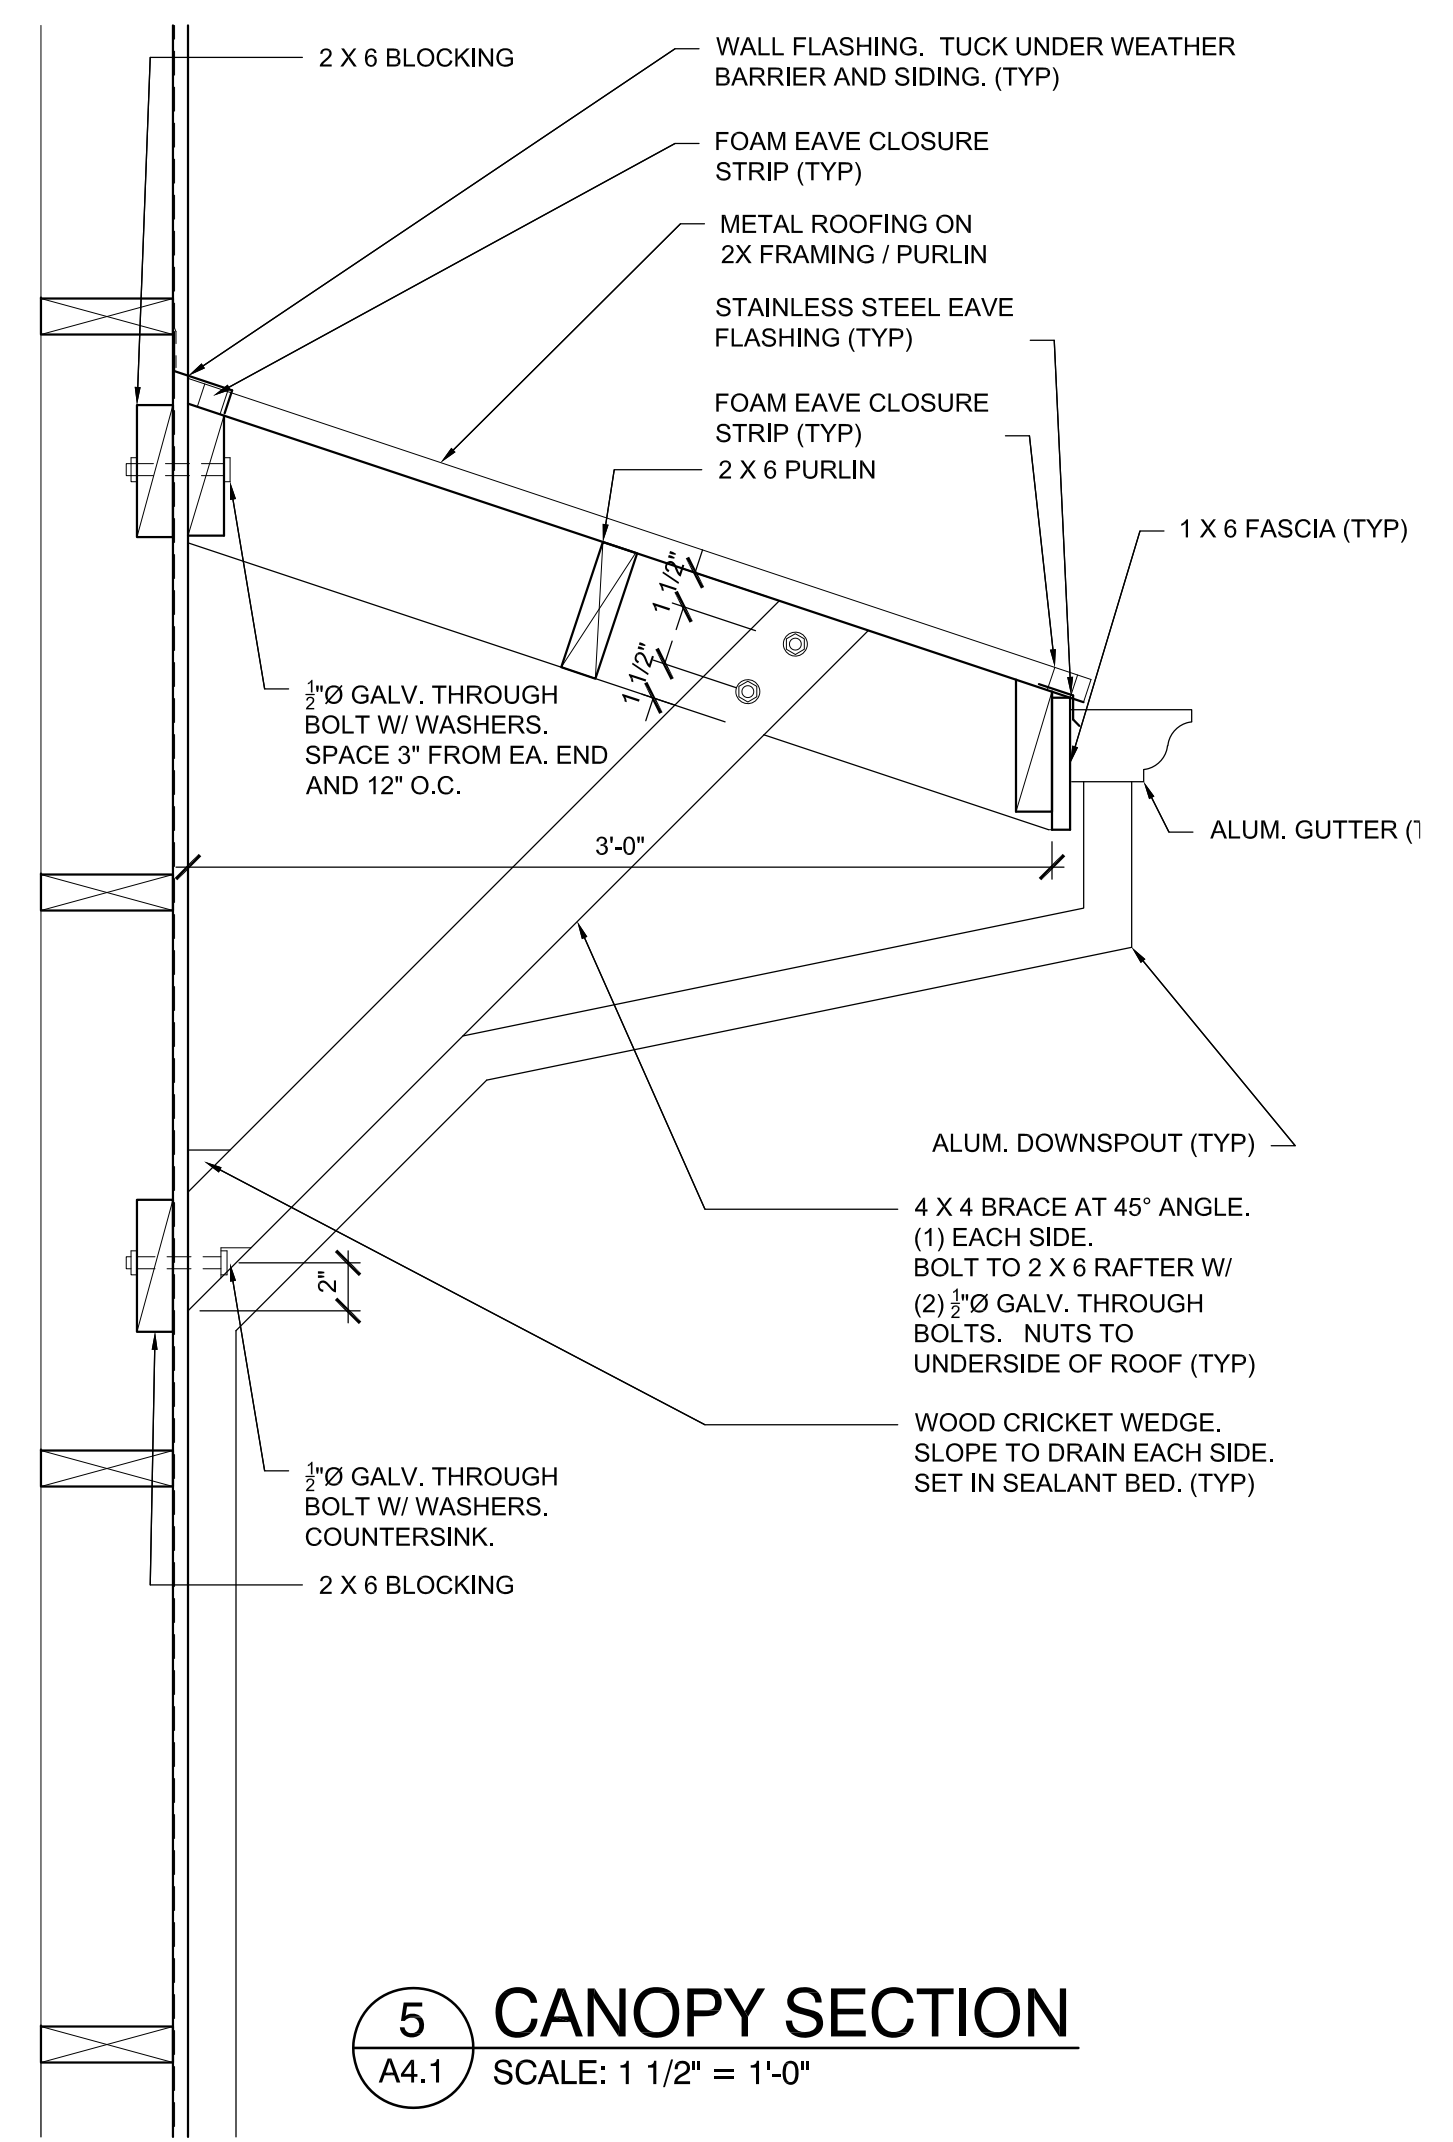


**5 CANOPY SECTION**  
A4.1 SCALE: 1 1/2" = 1'-0"

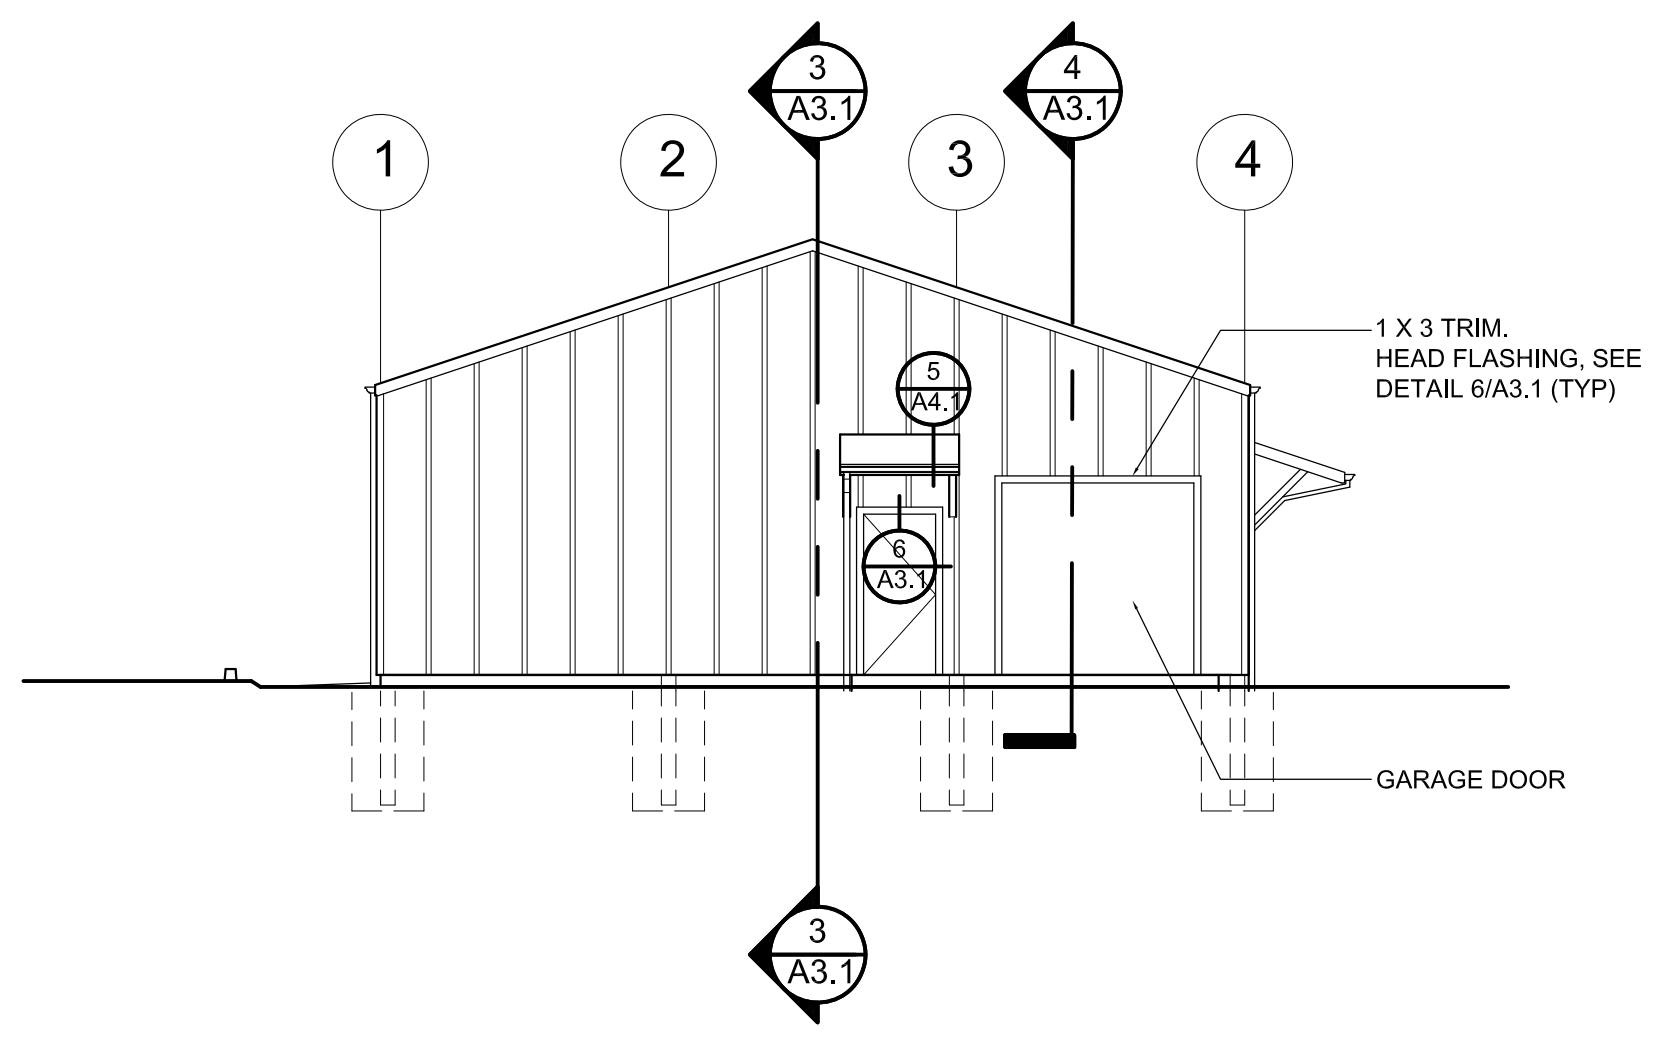


**4 NORTH EAST ELEVATION**  
A4.1 SCALE: 1/8" = 1'-0"

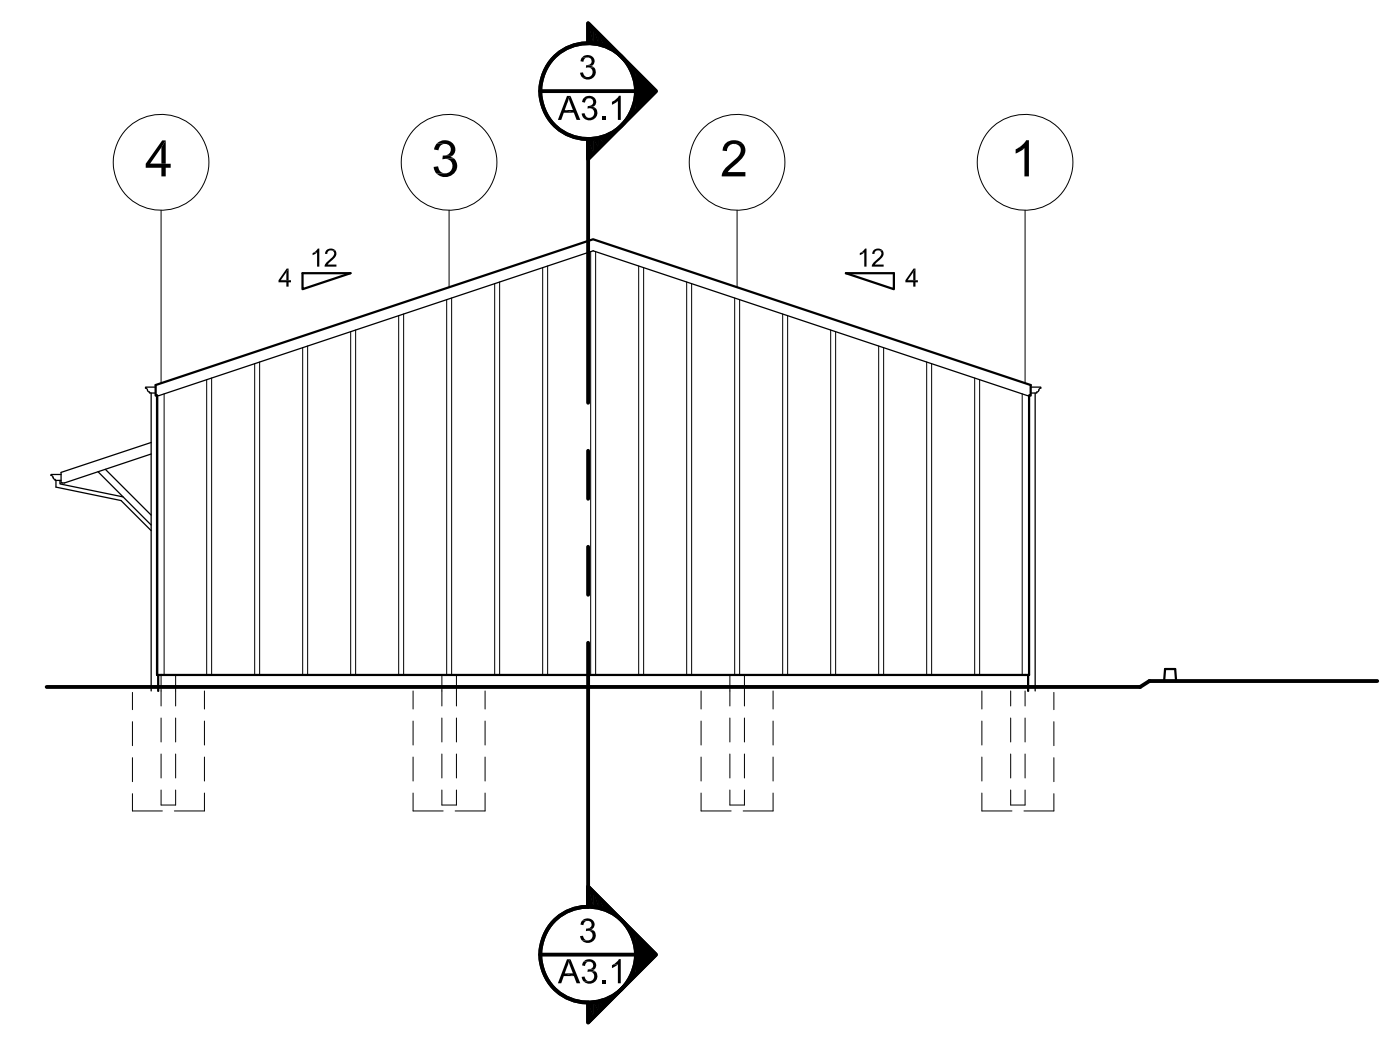


**3 SOUTH WEST ELEVATION**  
A4.1 SCALE: 1/8" = 1'-0"

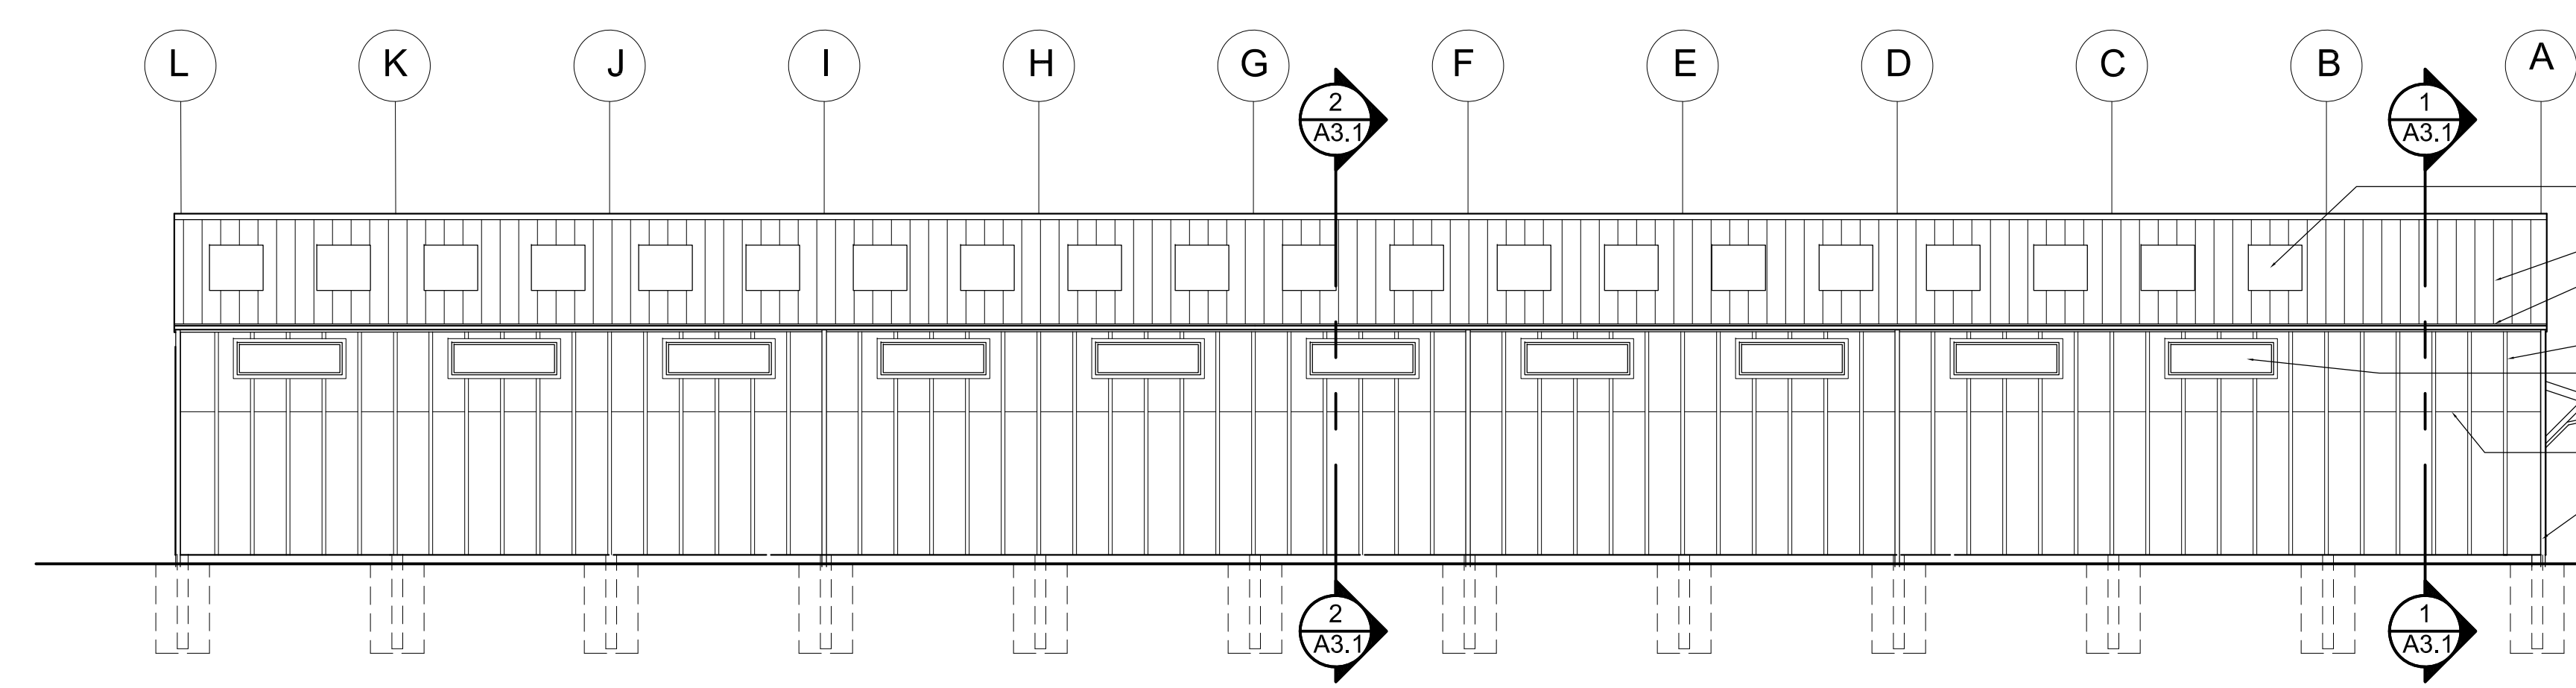

**2 SOUTH ELEVATION**  
A4.1 SCALE: 1/8" = 1'-0"

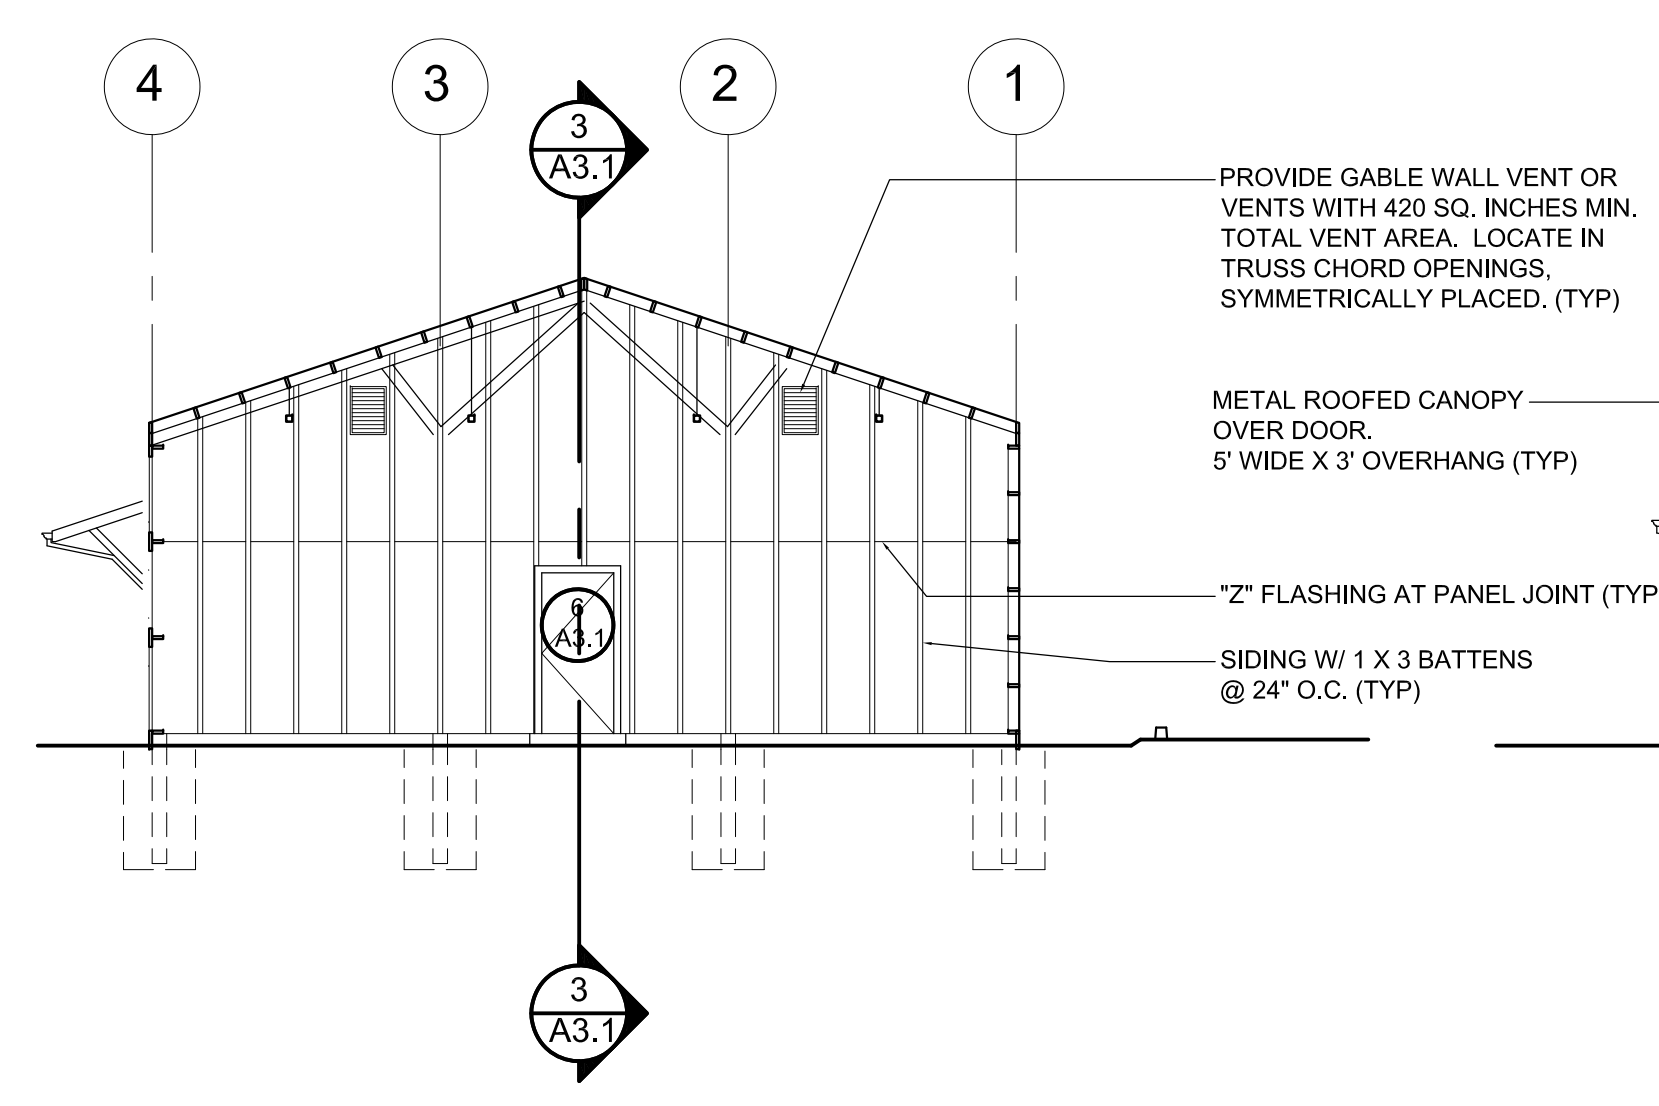

**6 TEAM ROOM / STORAGE ELEVATION**  
A4.1 SCALE: 1/8" = 1'-0"

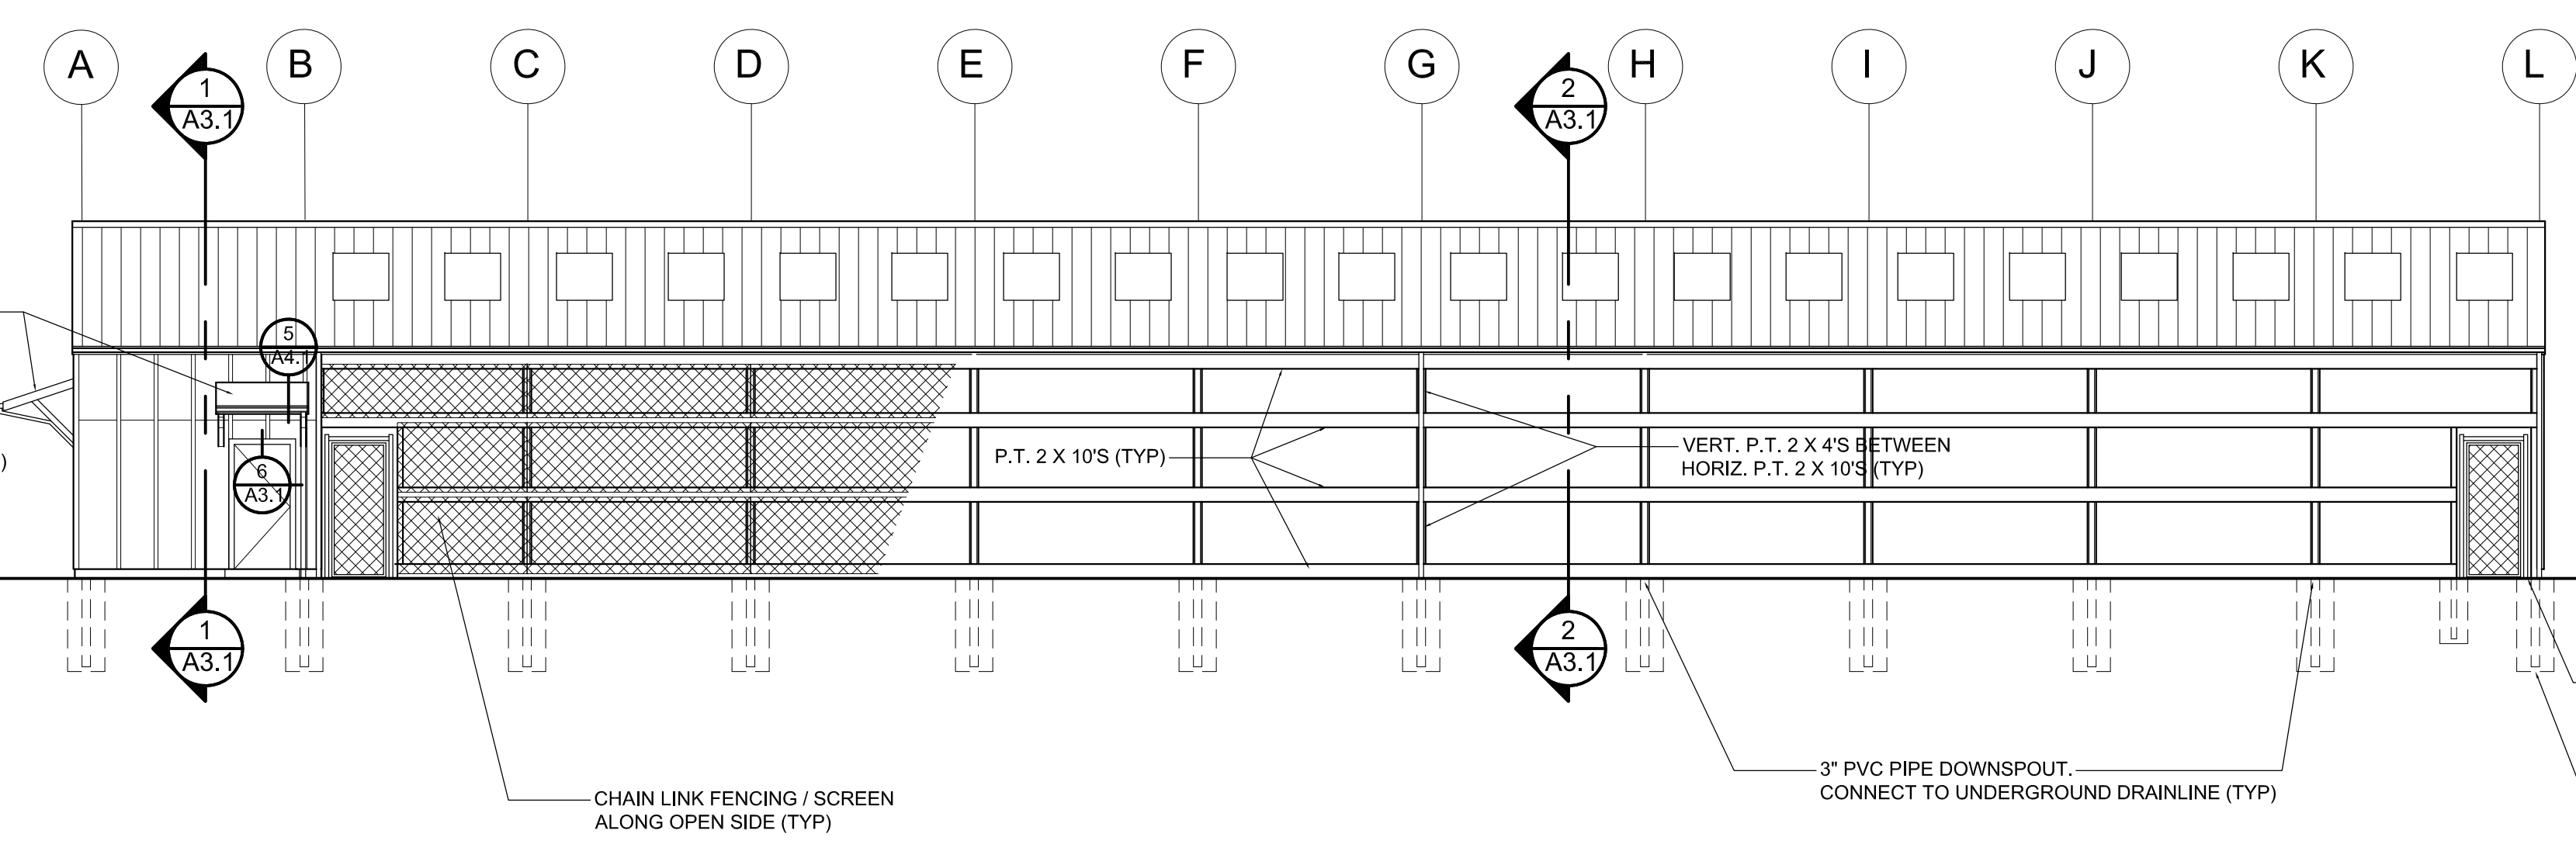

**1 NORTH ELEVATION (FRONT)**  
A4.1 SCALE: 1/8" = 1'-0"

**GENERAL BUILDING DATA:**

ITEMS	FEET
WIDTH:	36'-0"
LENGTH:	132'-0"
EAVE HEIGHT:	14'-0 MAX"
ROOF PITCH:	4
FRAME SPACING:	12'-0"
RAFTER SPACING:	SEE S1.0
GIRT SPACING:	2'-0"

**DESIGN CRITERIA**

ITEMS	UNIT
WIND SPEED	120
EXPOSURE	B
SEISMIC ZONE	D
DEAD LOAD	5 psf
SOIL BEARING	1500 psf
GROUND SNOW	25 psf
SD	1.321
R	4

WOOD

STRUCTURAL LUMBER SHALL CONFORM TO WESTERN SOFTWOOD ASSOCIATION FOR GRADING.  
 -POSTS SHALL BE 6 X P.T HF#2 U.N.O  
 -POSTS SHALL BE PRESSURE TREATED TO 0.60 pcf RETENTION CCA ACCORDANCE WITH UBC STD 25-12 AND A.W.P.A LP-44.  
 -POSTS SHALL BE CENTERED ON THE FOOTING.  
 -GIRTS SHALL BE 2 X 6 DF#2 @ 24" O.C U.N.O  
 -RAFTERS SHALL BE 2 X 6 DF#2 @ 24" O.C U.N.O

FASTENERS, ANCHORS AND CONNECTORS

- BOLTS SHALL BE 3/4 DIAMETER MACHINE BOLTS WITH WASHERS AND NUTS AND SHALL CONFORM TO ASTM.  
 - WHERE BOLTS COME INTO CONTACT WITH PRESSURE TREATED WOOD WHEN CHEMONITE IS USED THEY SHALL BE GALVANIZED STEEL.  
 - NUTS FOR BOLTS SHALL BE EITHER CROWN NUTS OR NYLON LOCKNUTS AND SHALL BE TIGHTENED TO THE APPROPRIATE MANUFACTURER'S RECOMMENDATIONS.  
 - NAILS IN TREATED WOOD SHALL BE HOT DIPPED GALVANIZED

GIRT TO POST RAFTER TO BLOCKING BLOCKING TO TRUSS (NAILS AT EACH SIDE U.N.O)	(3) 16d
---	---------

GENERAL NOTES

THE GENERAL CONTRACTOR SHALL VERIFY ALL DIMENSIONS AND SITE CONDITIONS BEFORE STARTING WORK. THE OWNER /CONTRACTOR SHALL NOTIFY THE BUILDING CODE DIVISION OF ANY DESCREPENCIES. CHANGES,OMISSIONS OR SUBSTITUTIONS ARE NOT PEMITTED WITHOUT THE APPROVAL OF THE BUILDING DEPARTMENT HAVING JURISDICTION. ALL WORKMANSHIP SHALL CONFORM TO OREGON STRUCTURAL SPECIALTY CODE.

THE STRUCTURE IS DESIGNED TO FUNCTION AS A UNIT UPON COMPLETION . THE CONTRACTOR/OWNER IS RESPONSIBLE FOR METHODS AND/ SEQUENCES OF ASSEMBLING THE STRUCTURE. THE CONTRACTOR/OWNER IS RESPONSIBLE FOR THE STABILITY OF THE STRUCTURE DURING THE CONSTRUCTION AND PRIOR TO COMPLETION OF ALL WALLS, ROOF AND FLOOR DIAPHRAGMS

DRILLED FOUNDATION

THE FOOTING SHALL BEAR ON NATIVE, INORGANIC, UNDISTURBED NATIVE SOIL BELOW EXISTING GRADE. ALL STRUCTURAL FOOTINGS SHALL BE EXTENDED MINIMUM 4'-0" BELOW FINISHED GRADE UNLESS NOTED OTHERWISE ON PLANS. THERE SHALL BE 95% COMPACTION OF ALL BACKFILL FOR SLAB ON GRADE IN ACCORDANCE OF ASTM D1557 MODIFIED PROCTOR DENSITY.

BACK FILL IN THE ANNULAR SPACE AROUND THE POSTS SHALL BE BY ONE OF THE FOLLOWING METHODS:


- A. CONCRETE WITH THE ULTIMATE STRENGTH OF MIN. 2000 PSI.
- B. CLEAN SAND: THE SAND SHALL BE COMPACTED BY TAMPING IN LAYERS NOT MORE THAN 8" IN DEPTH
- C. GRANULAR BACKFILL: THE GRANULAR BACKFILL SHALL BE 3/4 (-) GRAVEL OR CRUSHED ROCK. BACKFILL SHALL BE COMPACTED BY TAMPING IN LAYERS NOT MORE THAN 8" IN DEPTH.
- D. NO SPECIAL INSPECTION FOR COMPACTION BY TAMPING

CONCRETE SLAB ON GRADE IS NOT DESIGNED BY S&T CONSULTING. IT IS THE RESPONSIBILITY OF THE CONTRACTOR OR THE OWNER. THE SUBGRADE FOR THE SLAB SHALL BE PREPARED ACCORDING TO ASTM D1557. CONTROL JOINTS ARE RECOMMENDED TO CONTROL CRACKING.




333 S. 4TH STREET  
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www.hge1.com  
general@hge1.com

CONSULTING ENGINEERS

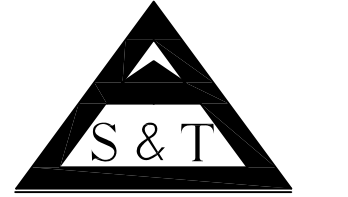

6635 Skyline Road S.  
Salem, OR 97306  
Tel. : (503) 931-2767

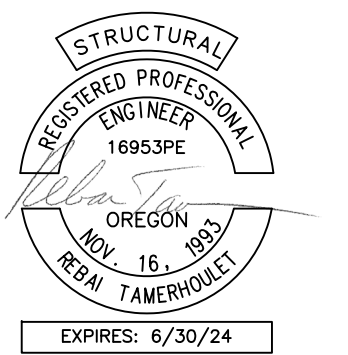

PROJECT NO.: 22.48  
MHS SOFTBALL BATTING CAGE STRUCTURE - REBID  
SOUTH COAST EDUCATION SERVICE DISTRICT FIELD  
1400 TEAKWOOD AVE.  
COOS BAY, OR 97420

**CONSTRUCTION**


REVISIONS:  
# DATE DESCRIPTION

DATE: OCTOBER 2023


SHEET TITLE:

**GENERAL NOTES**

**S0.0**

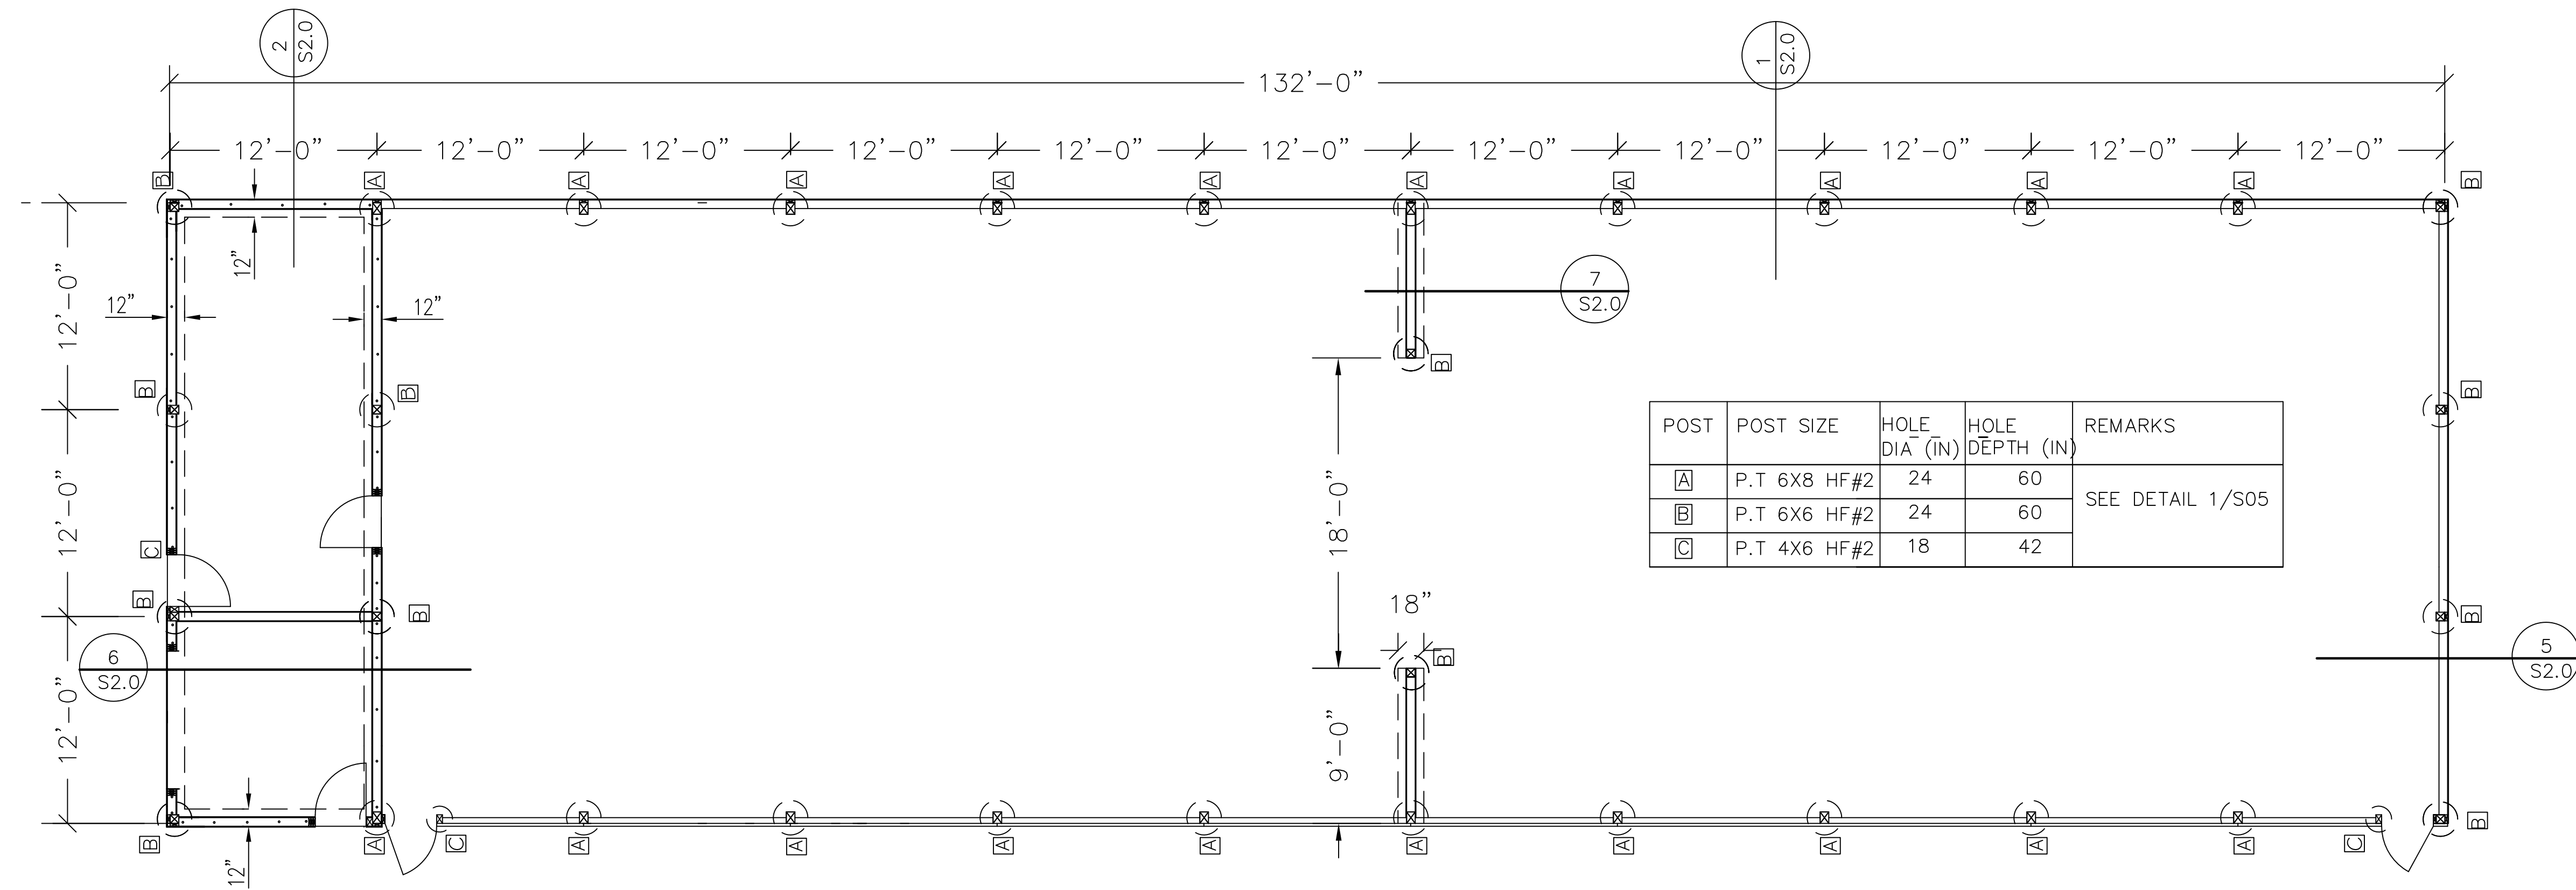



2 FOUNDATION/ FLOOR PLAN  
S1.0

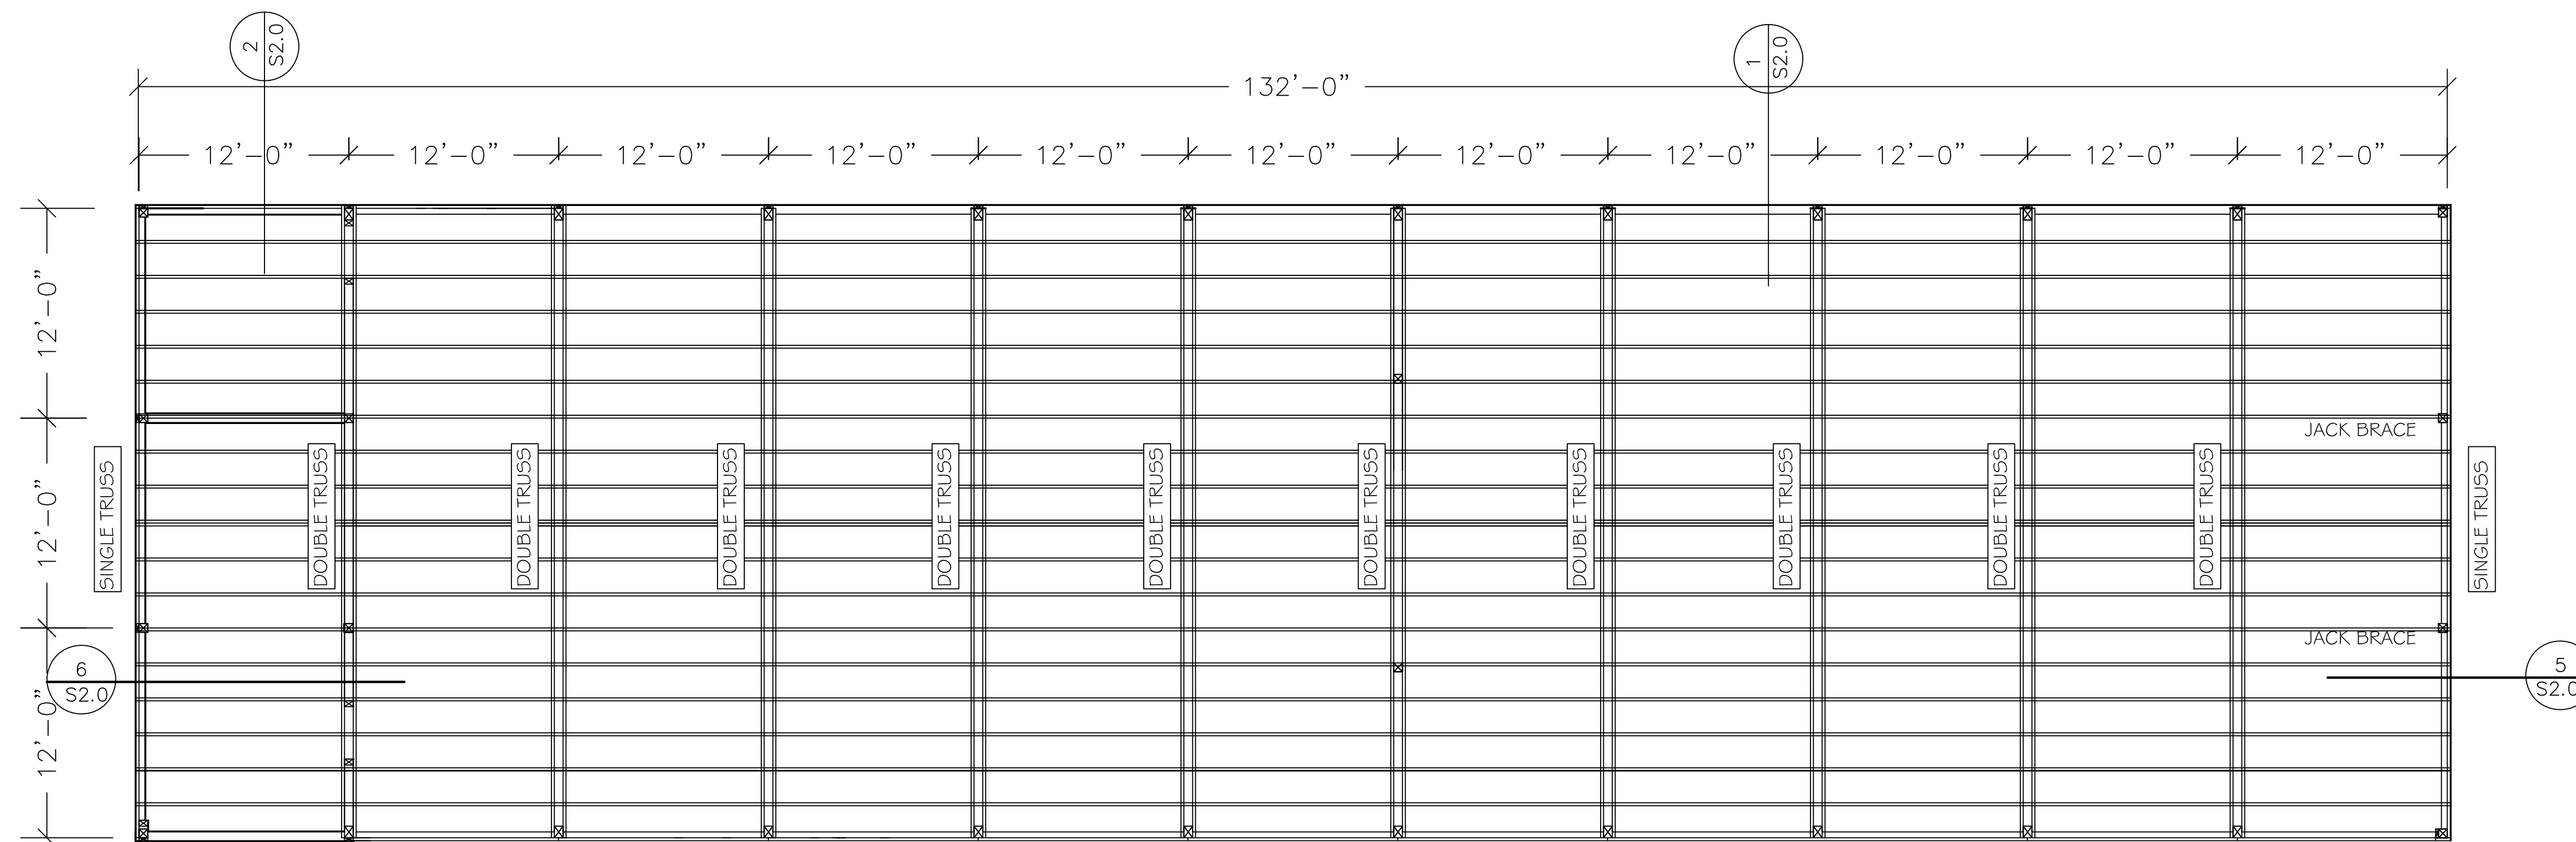

PLAN NOTES:

1. 2X6 DF#2 @ 24" O.C TYPICAL RAFTERS
2. MIN. 29 GAGE METAL ROOF SHEATHING PER 6/S3.0
3. MAX. 1'-0" OVERHANG (OPTIONAL)

2 ROOF FRAMING PLAN  
S1.0

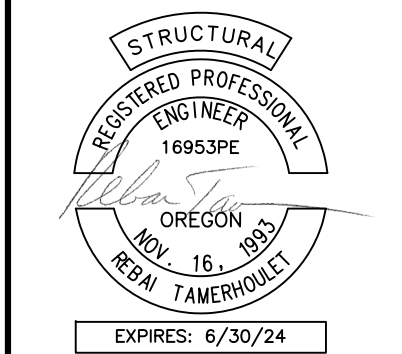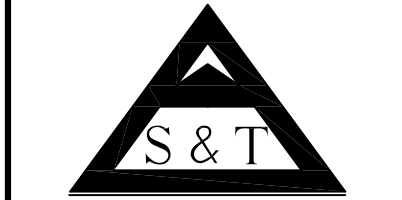



CONSTRUCTION

REVISIONS:	#	DATE	DESCRIPTION

DATE: OCTOBER 2023


SHEET TITLE:  
**PLANS**  
**-FOUNDATION**  
**-ROOF**

**S0.0**

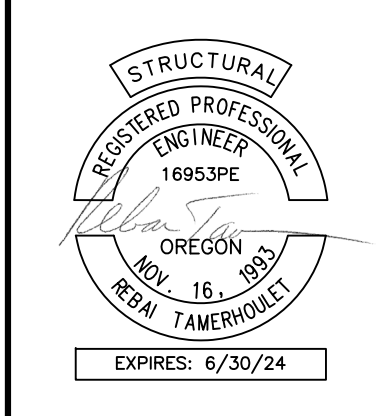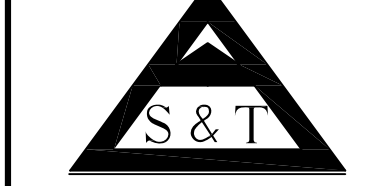


REVISIONS:


#	DATE	DESCRIPTION

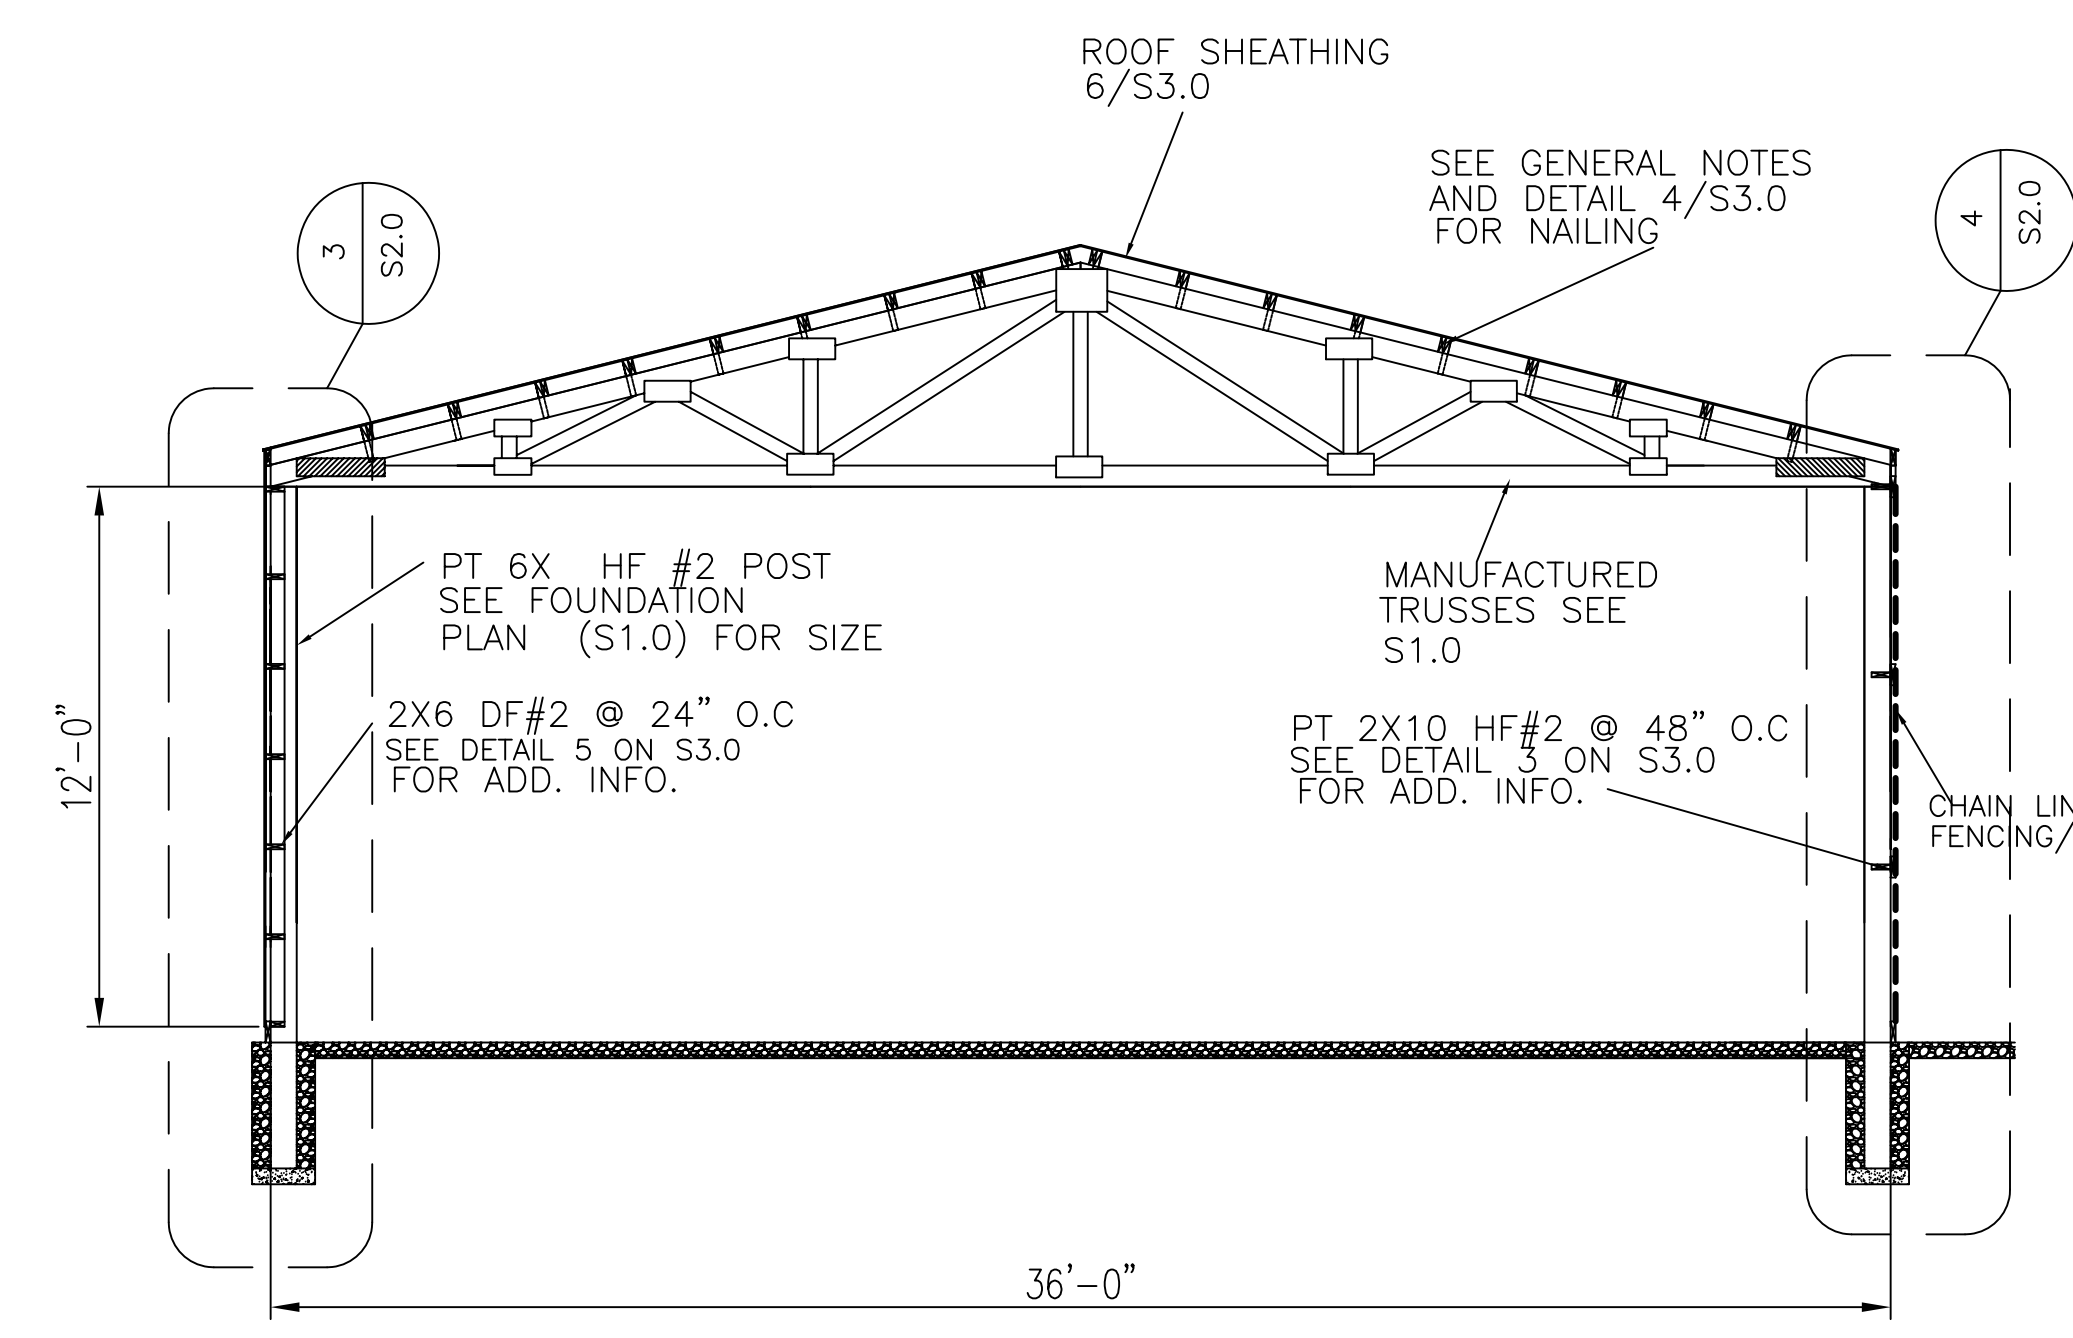

**1**  
S2.0  
TYPICAL BUILDING SECTION

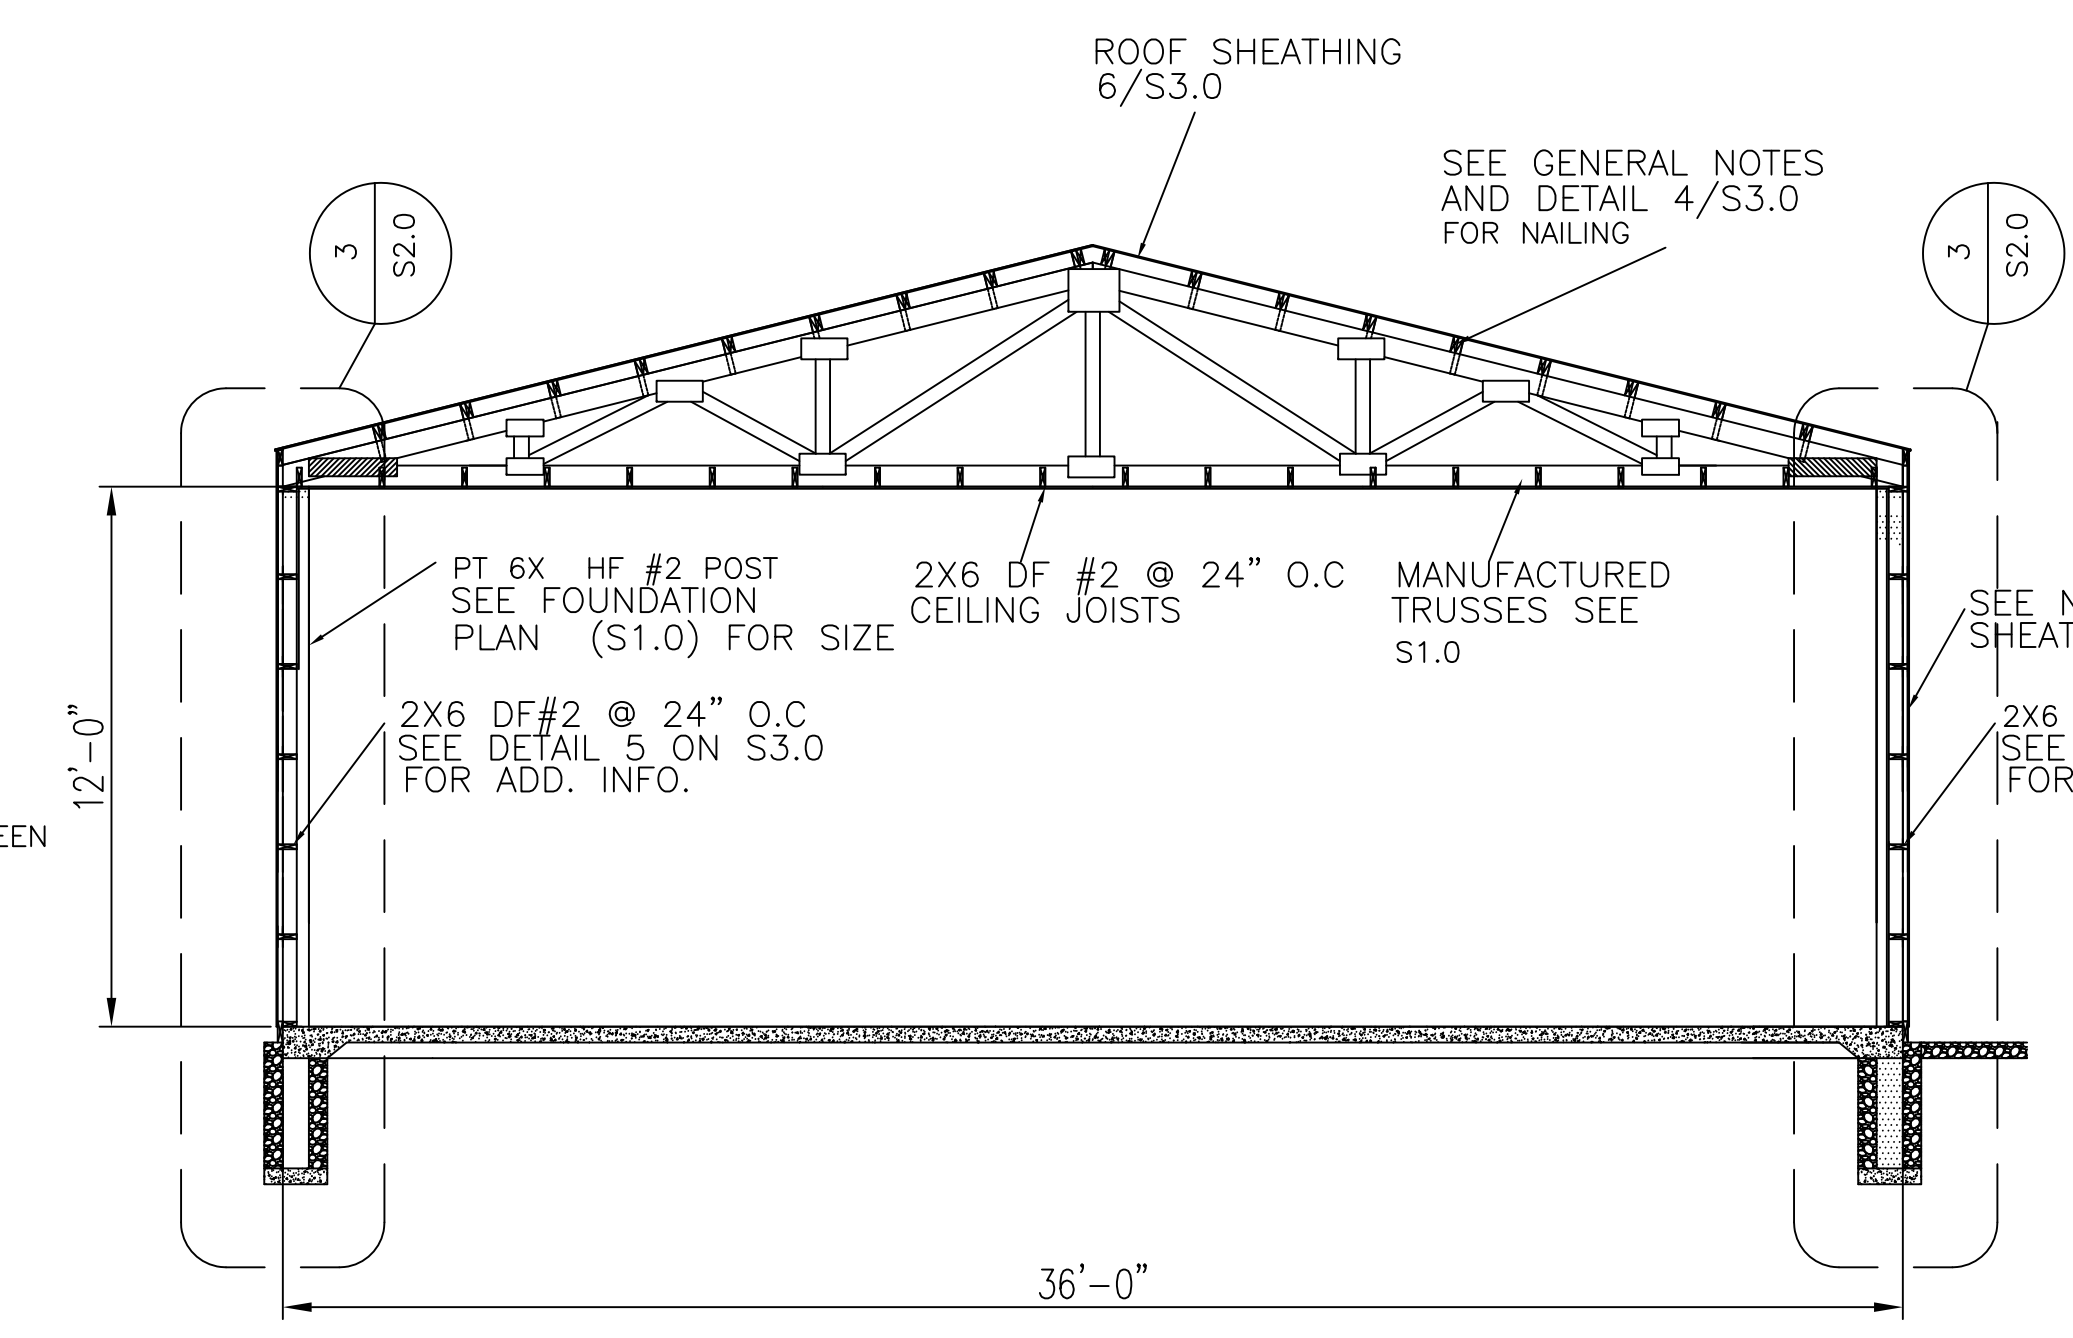


**2**  
S2.0  
TYPICAL BUILDING SECTION

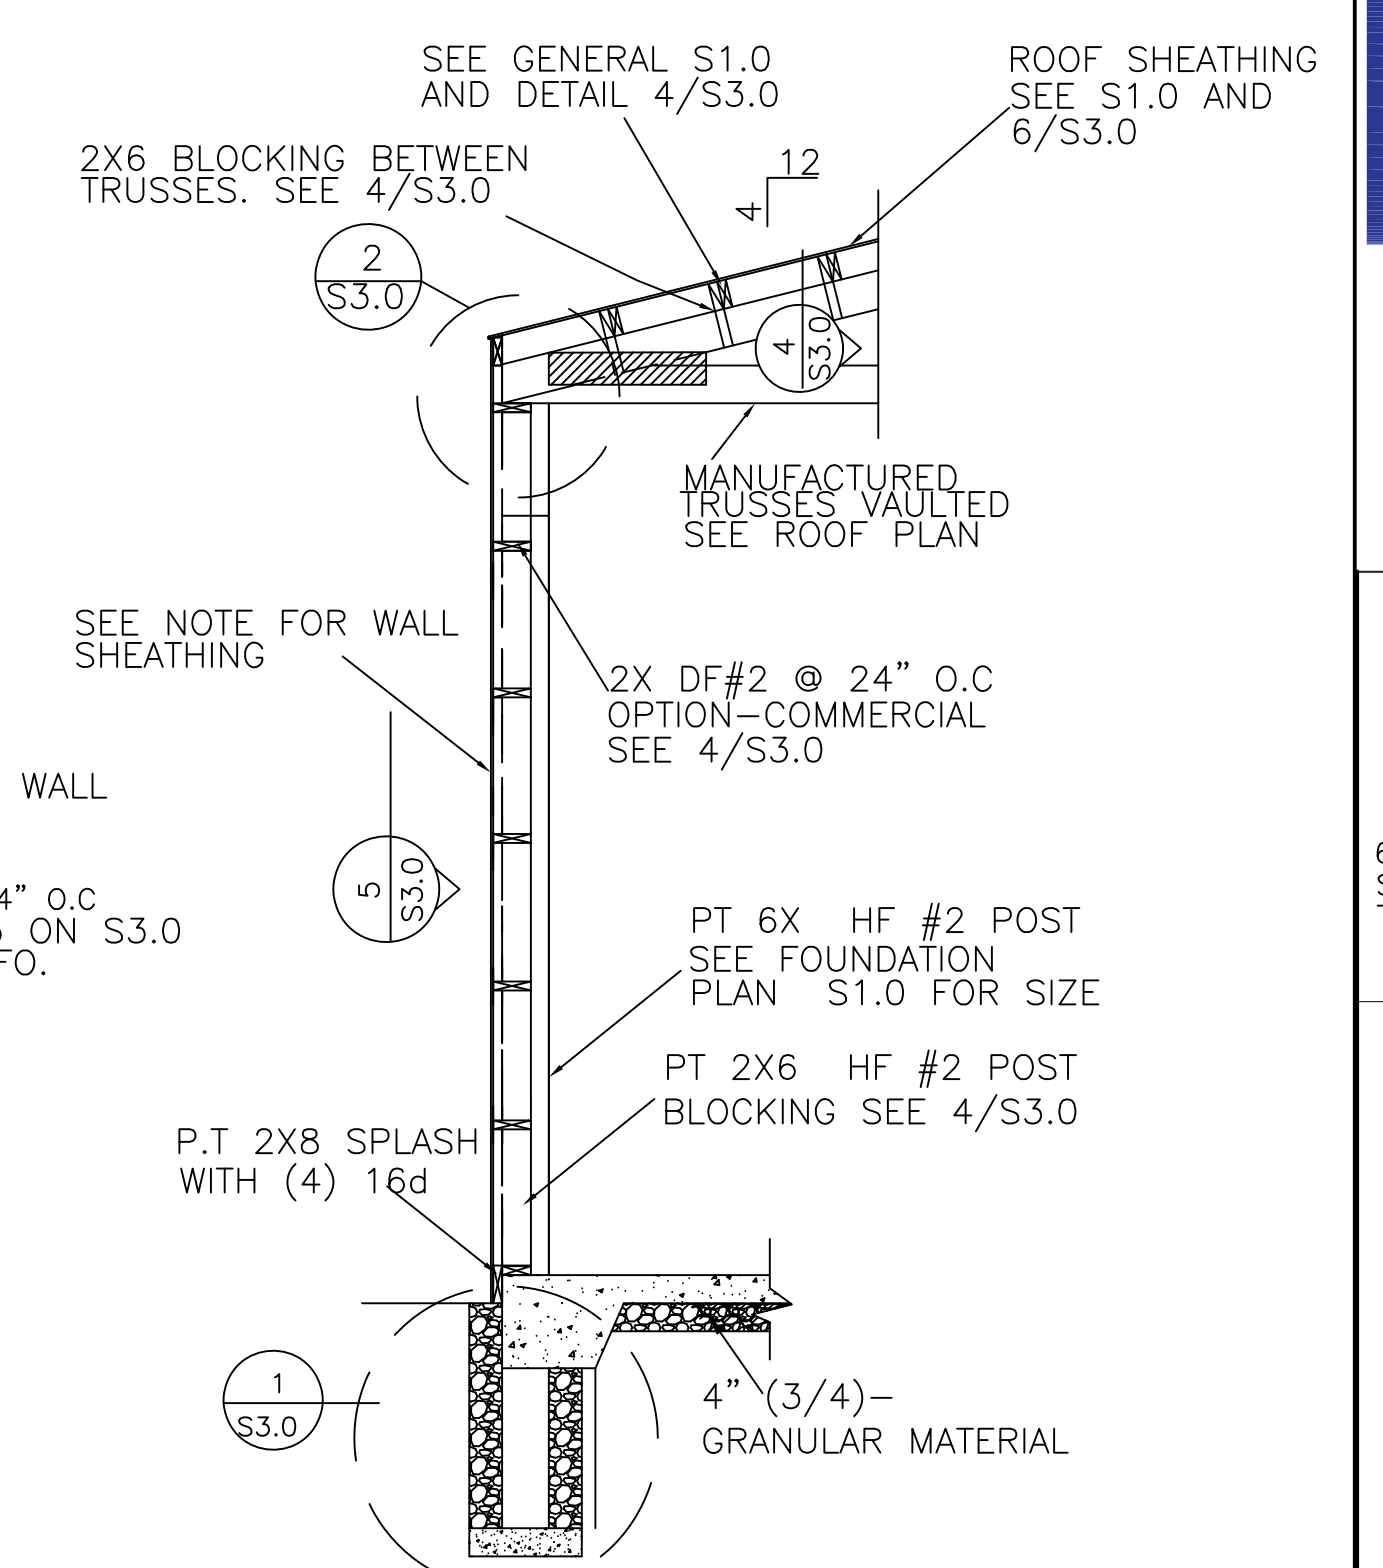


**3**  
S2.0  
FRAME SECTION/ SIDE WALL  
N.T.S


WALL SHEATHING NOTE:  
1/2" PLYWOOD SIDING WITH 8d@6" O.C EDGES AND 12" O.C FIELD  
BLOCK ALL JOINTS, AND 1X2 BATTENS @ 24" O.C

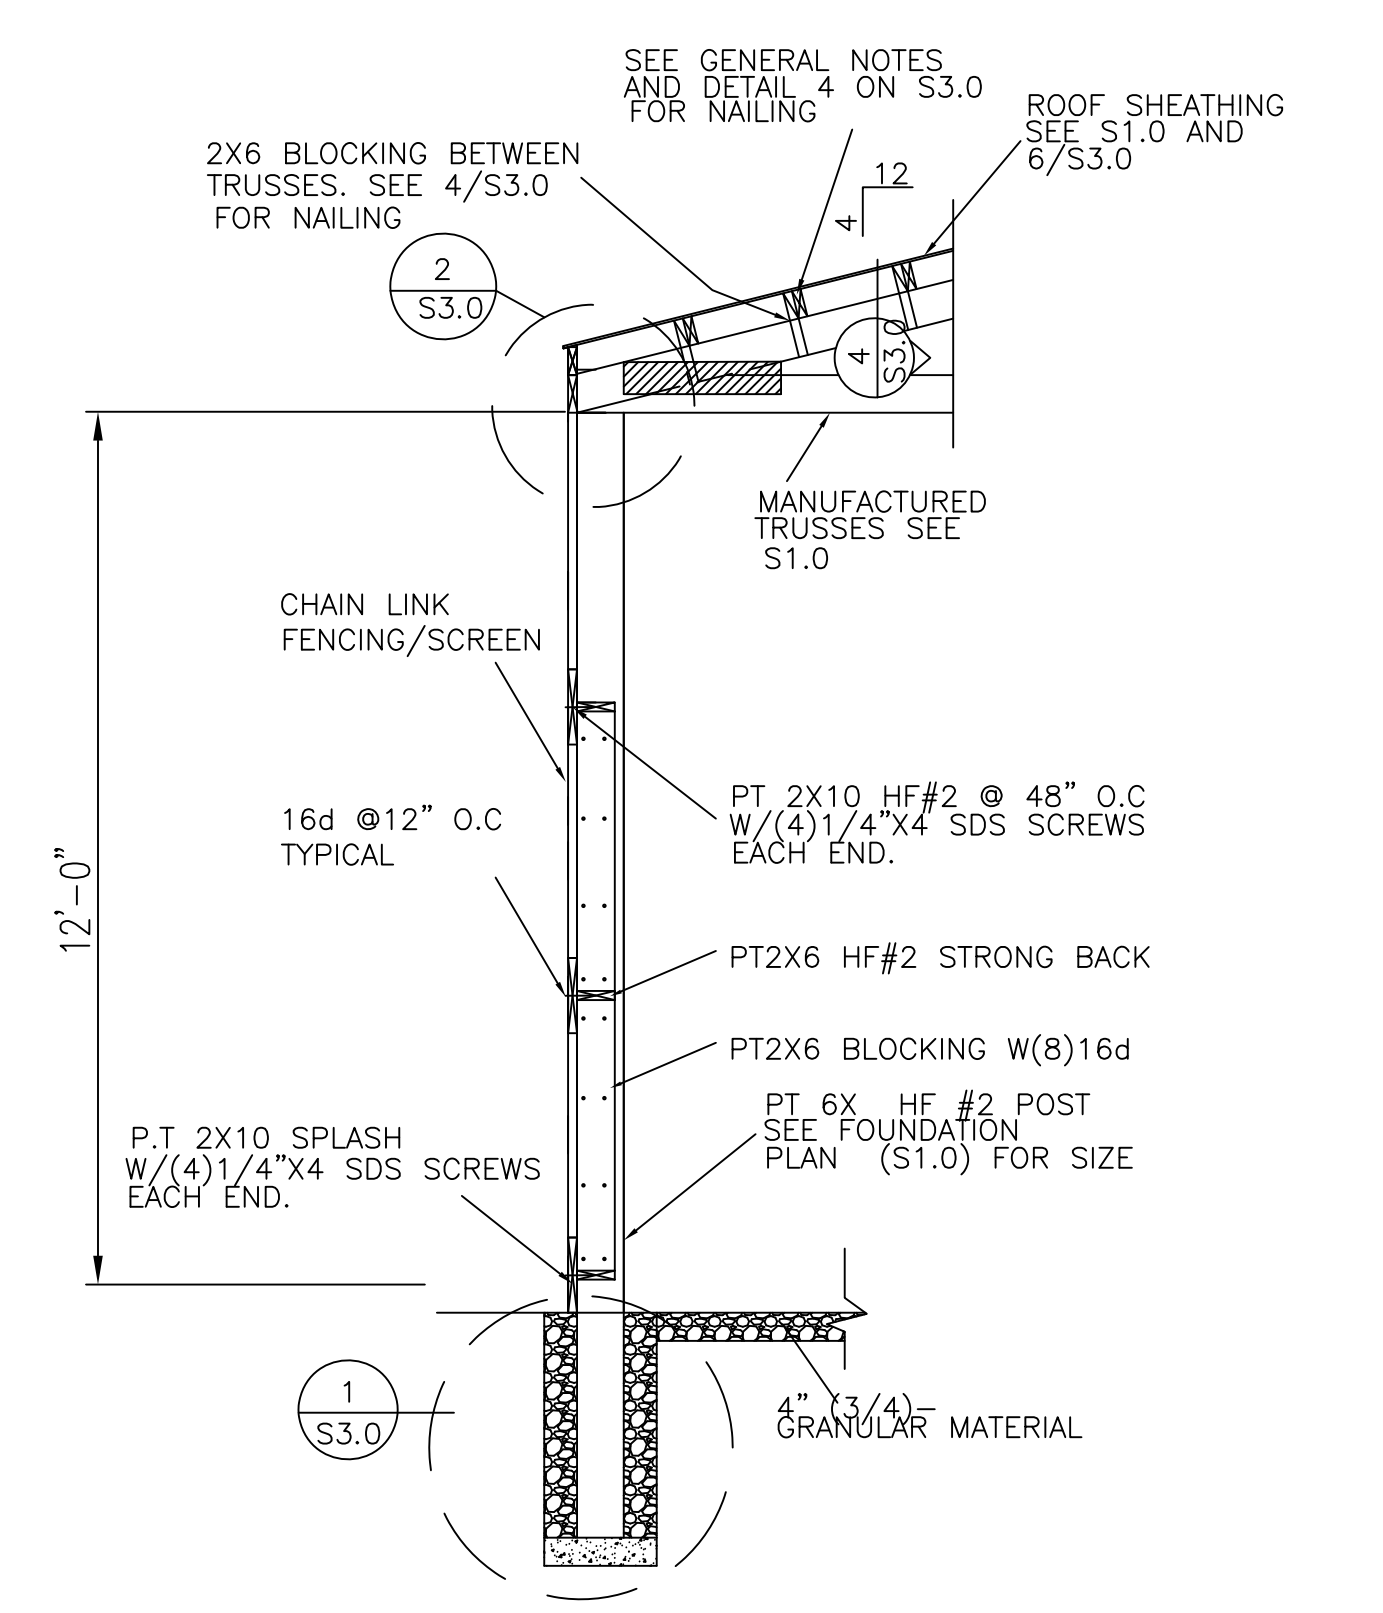


**4**  
S2.0  
FRAME SECTION/ SIDE WALL  
N.T.S

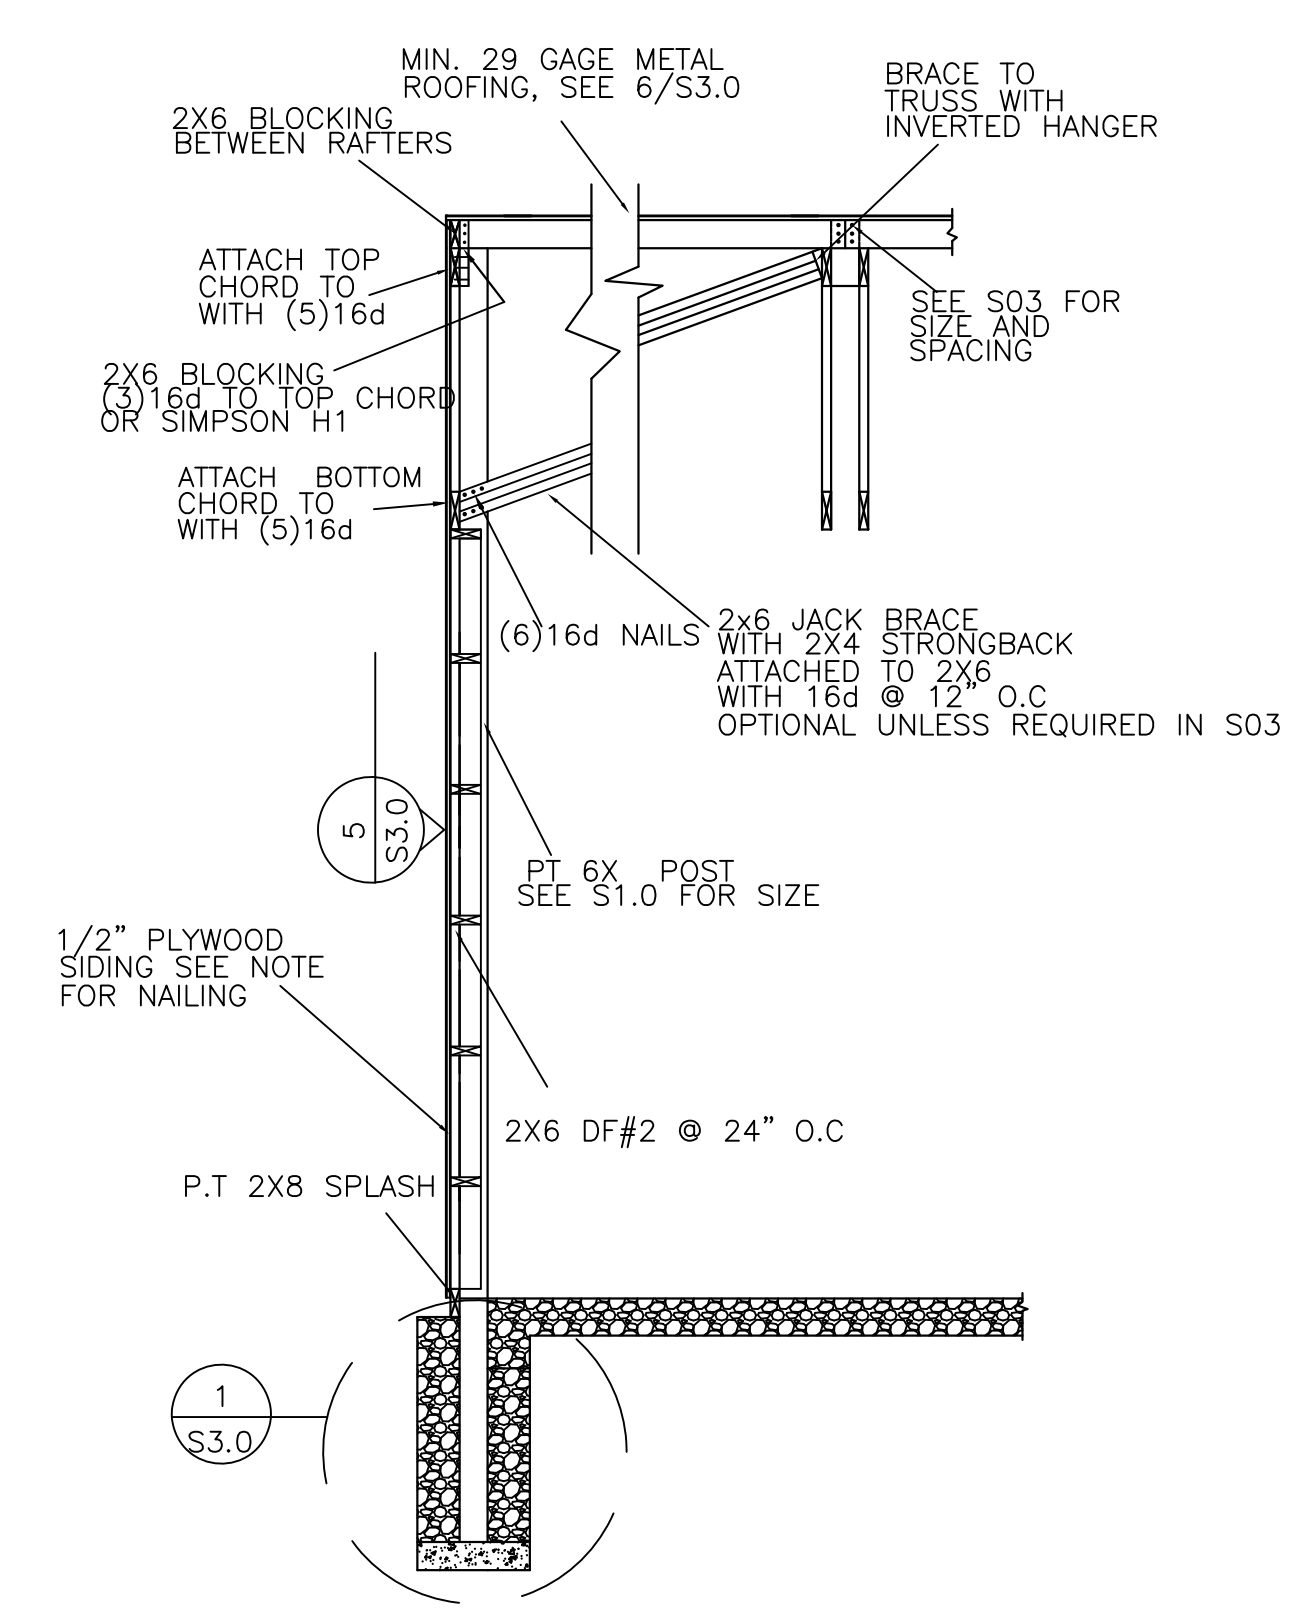

**5**  
S2.0  
FRAME SECTION/ GABLE WALL/OFFICE  
N.T.S

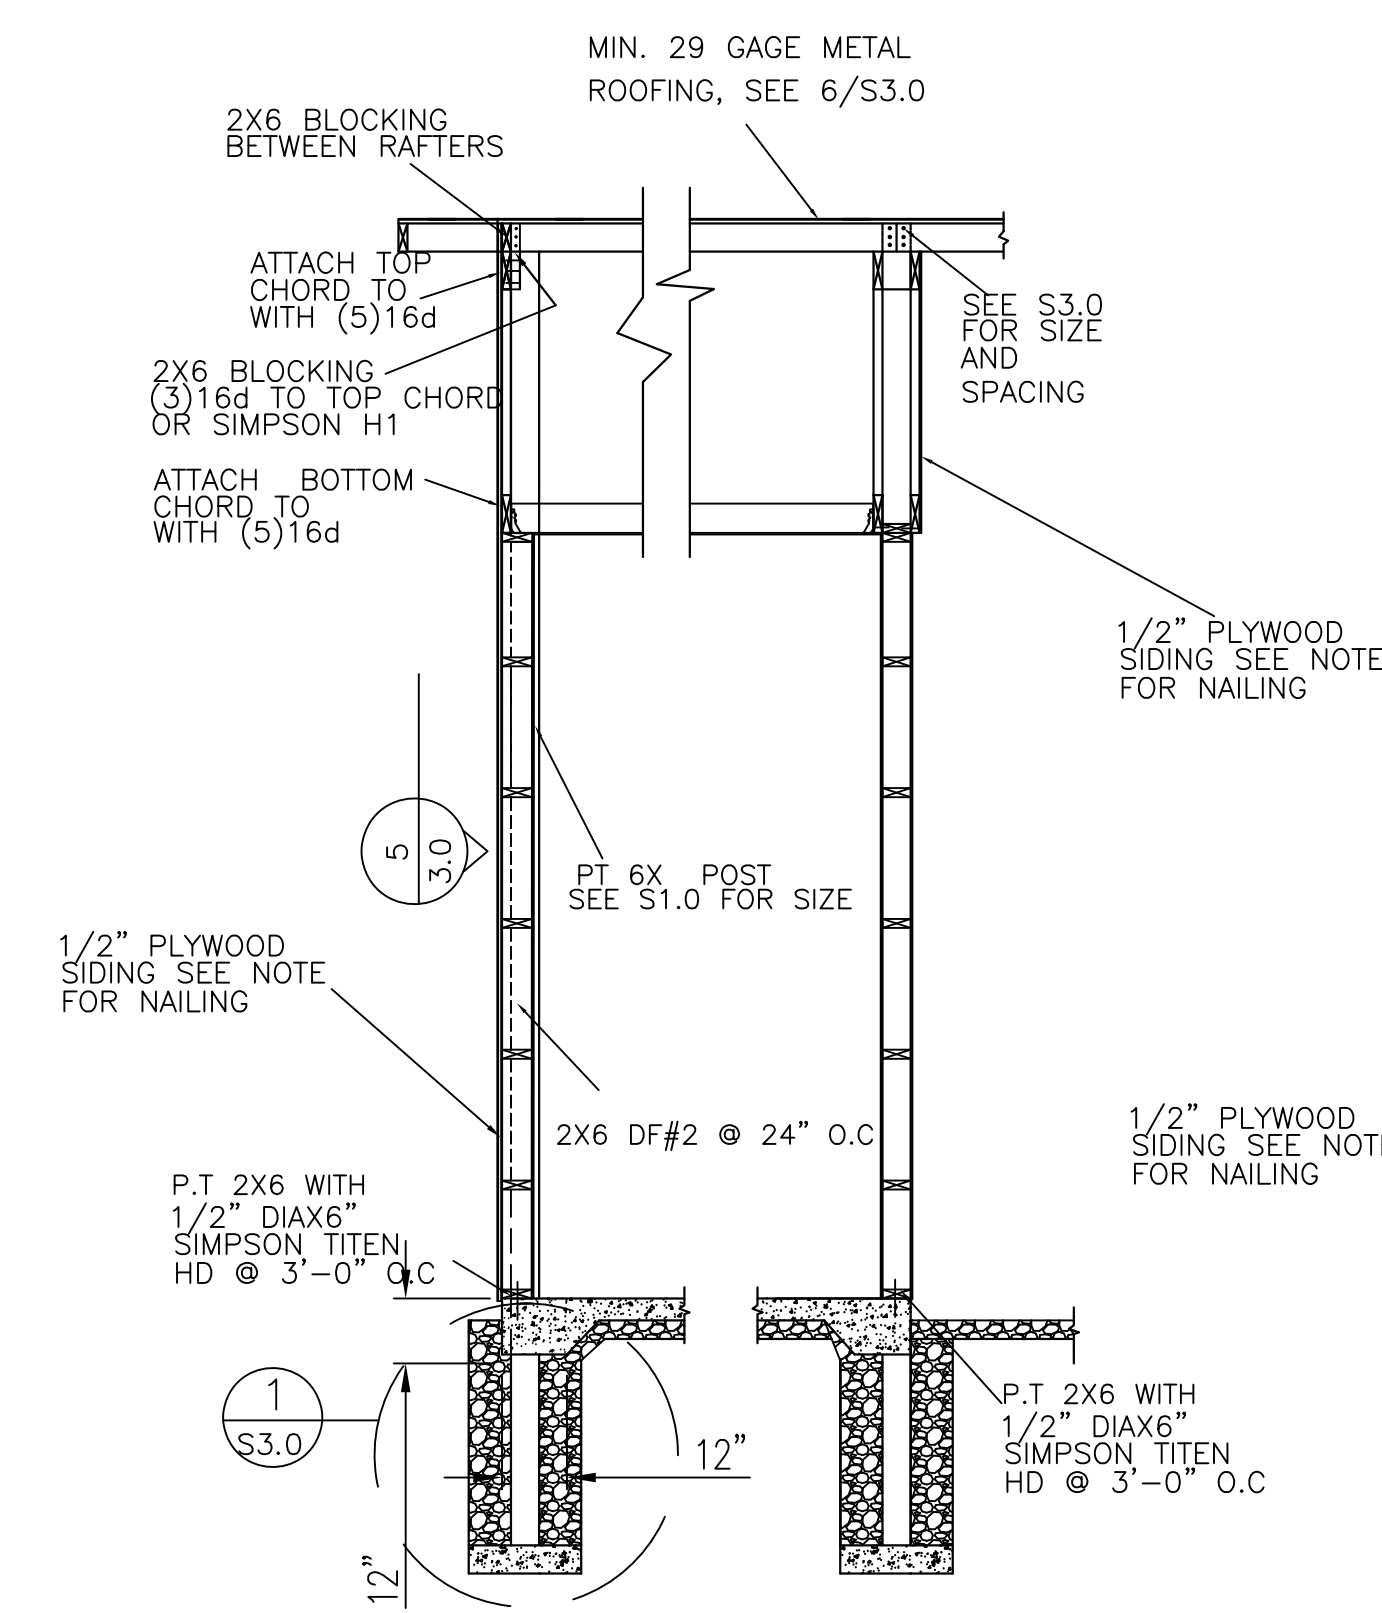


**6**  
S2.0  
FRAME SECTION/ GABLE WALL  
N.T.S

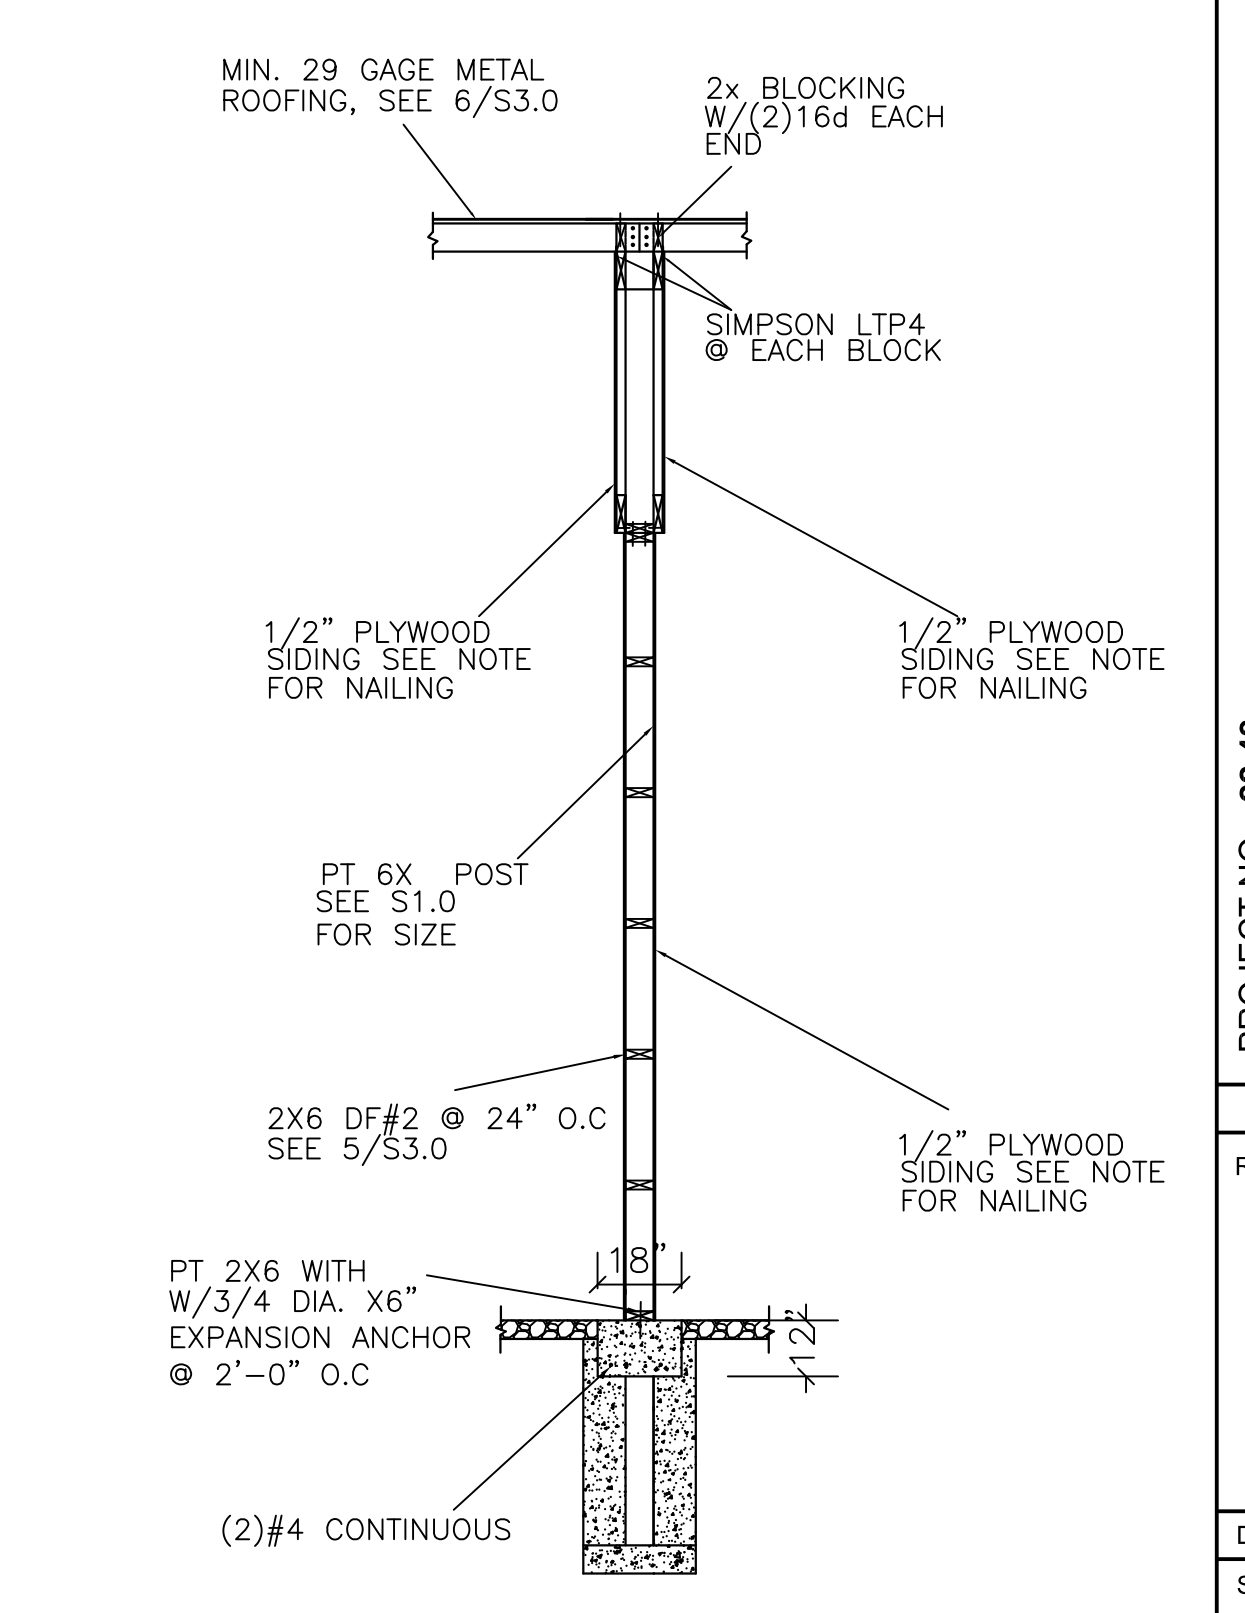


**7**  
S2.0  
SECTION AT INTERIOR SHEAR WALL  
N.T.S



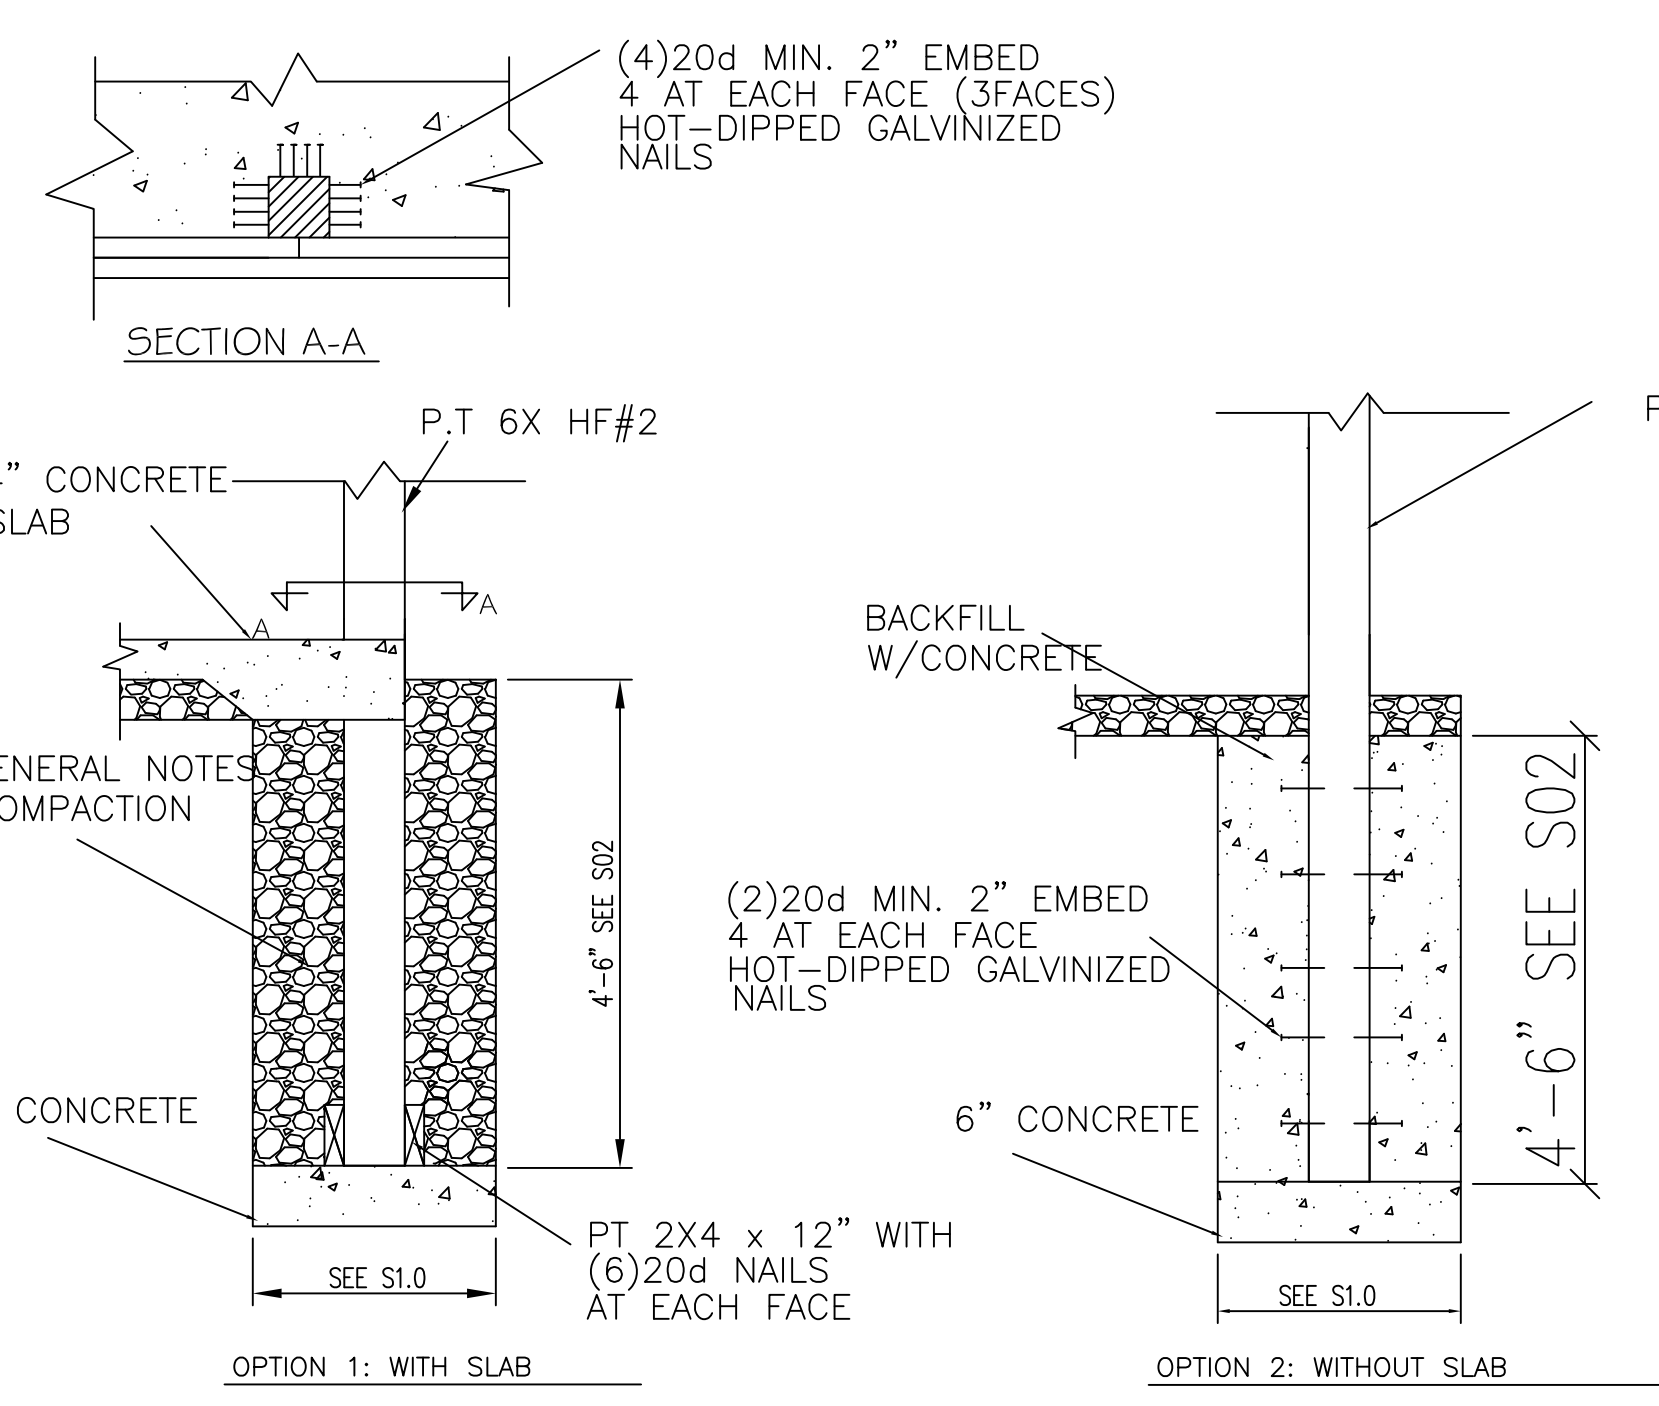


**1**  
S3.0 FOUNDATION DETAIL

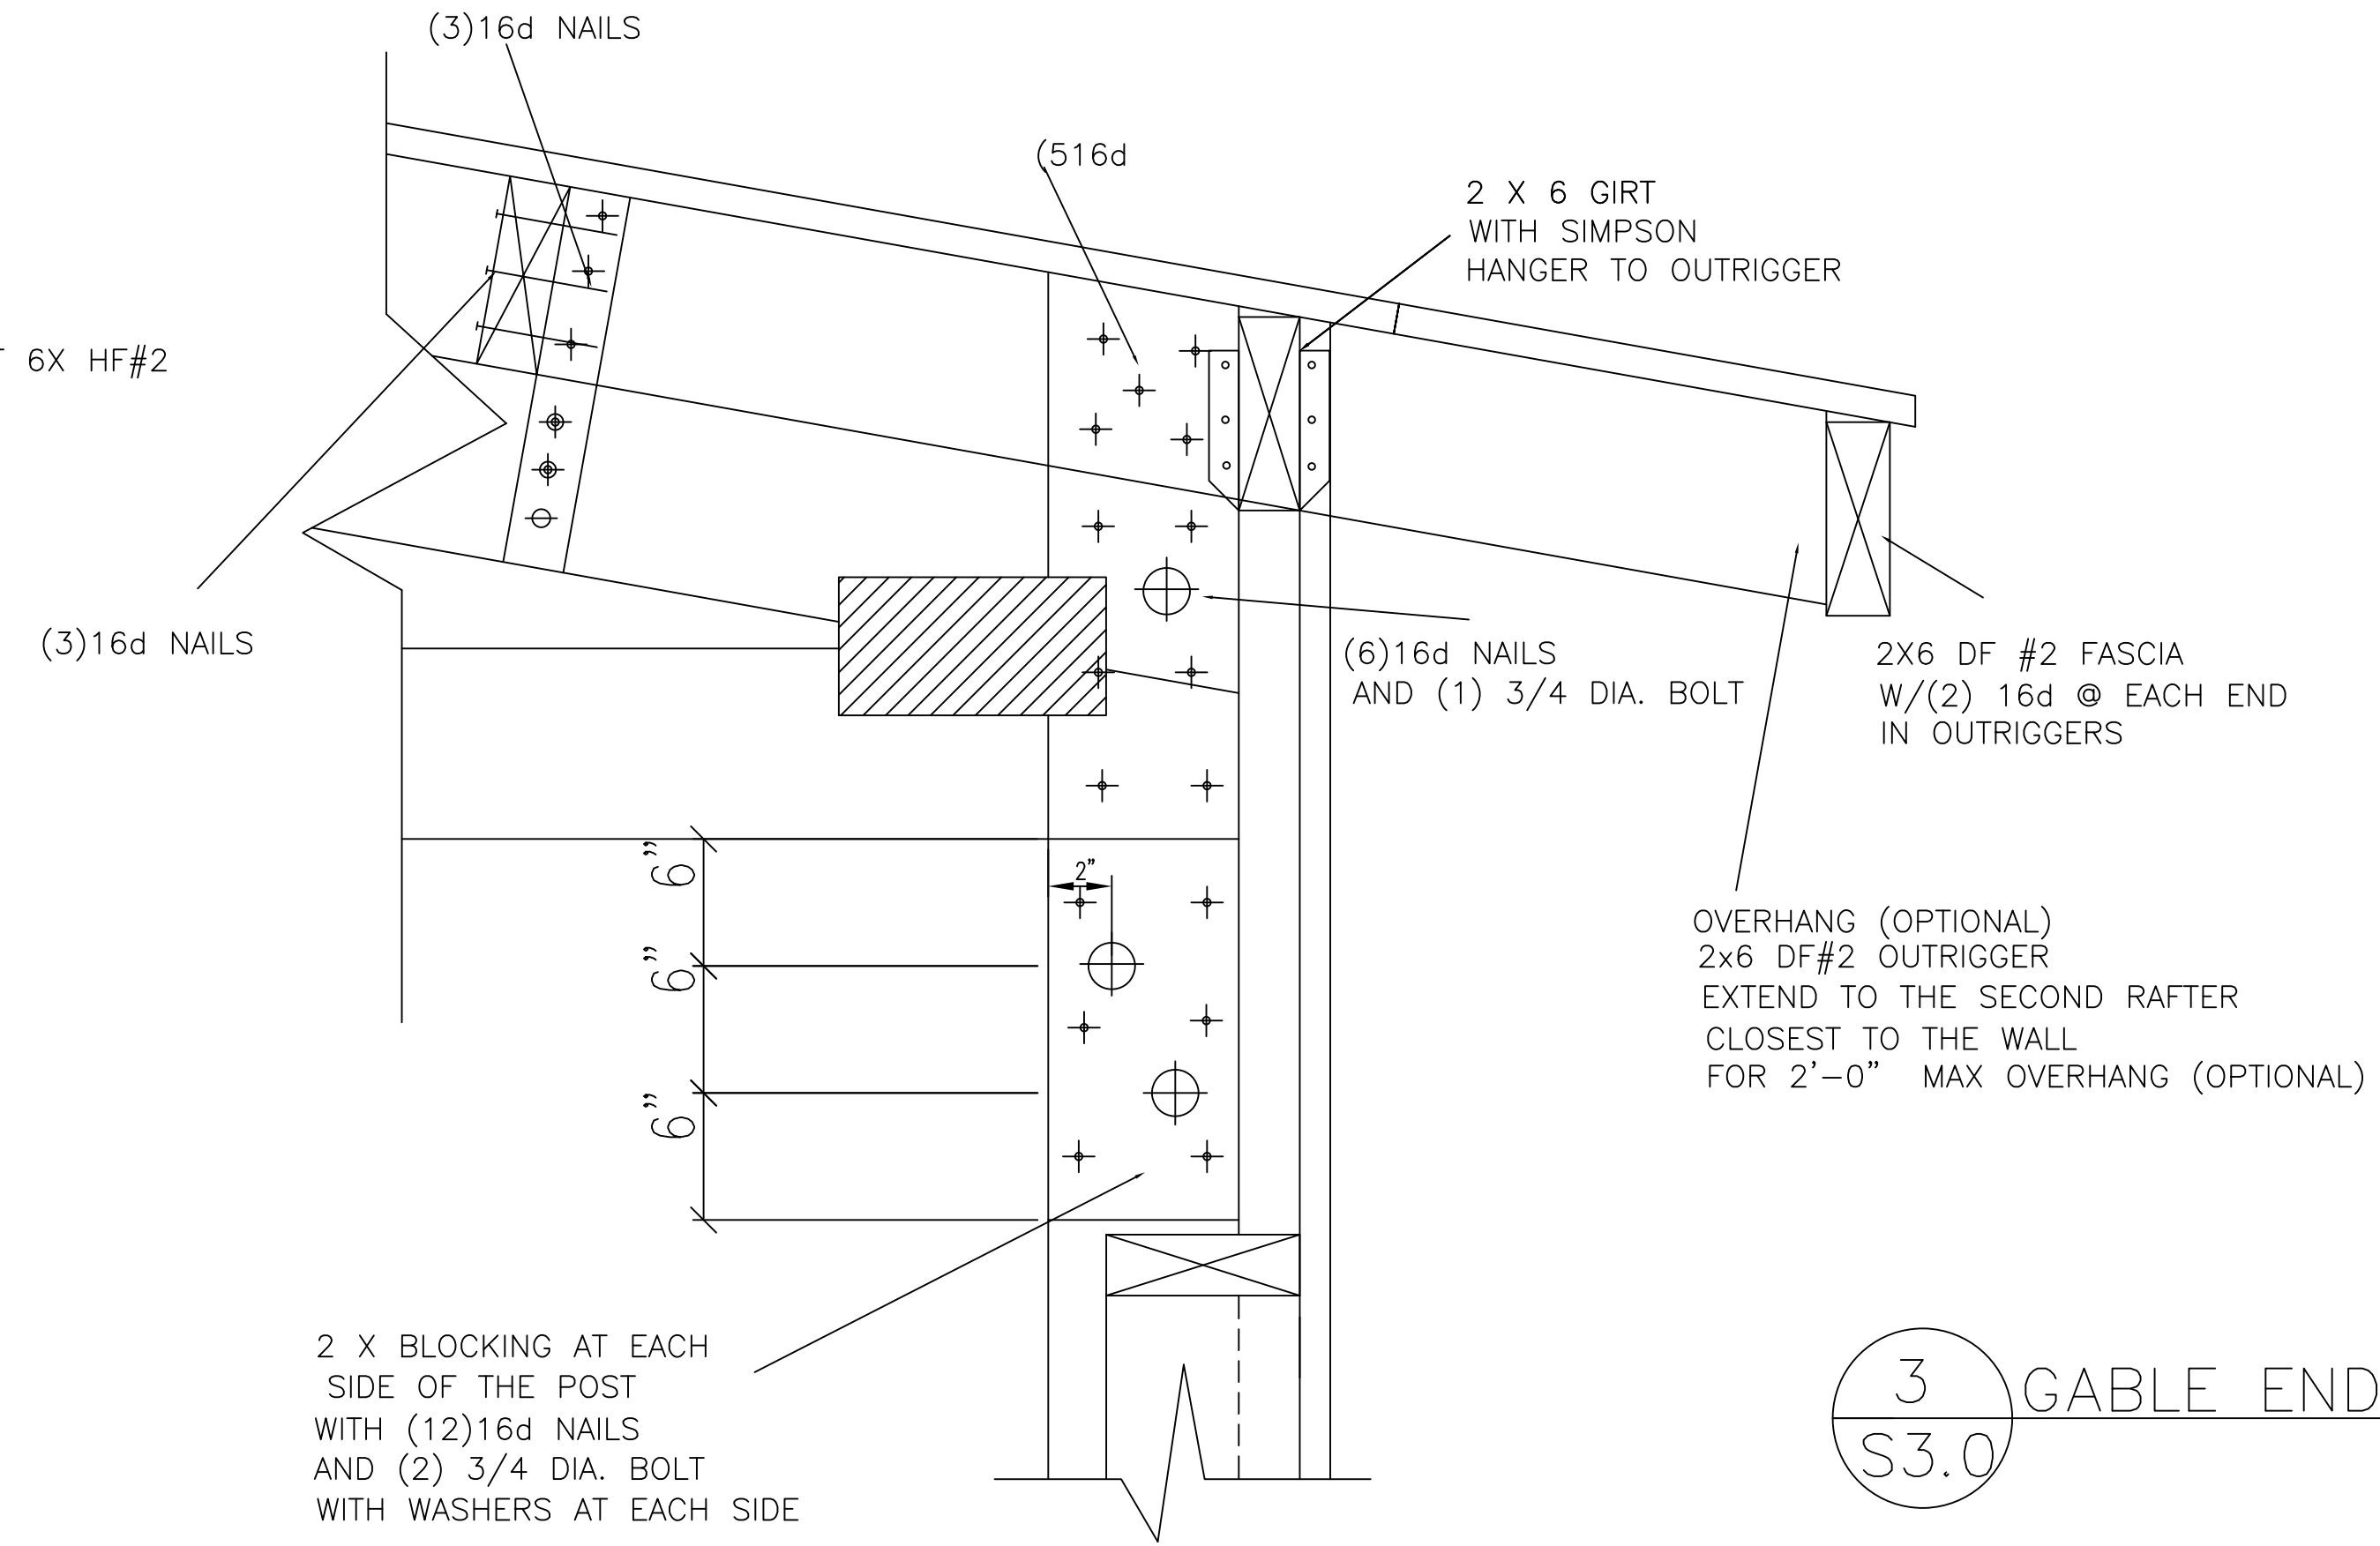


**2**  
S3.0 TRUSS TO POST CONNECTION DETAIL

**3**  
S3.0 GABLE END WALL TRUSS CONNECTION

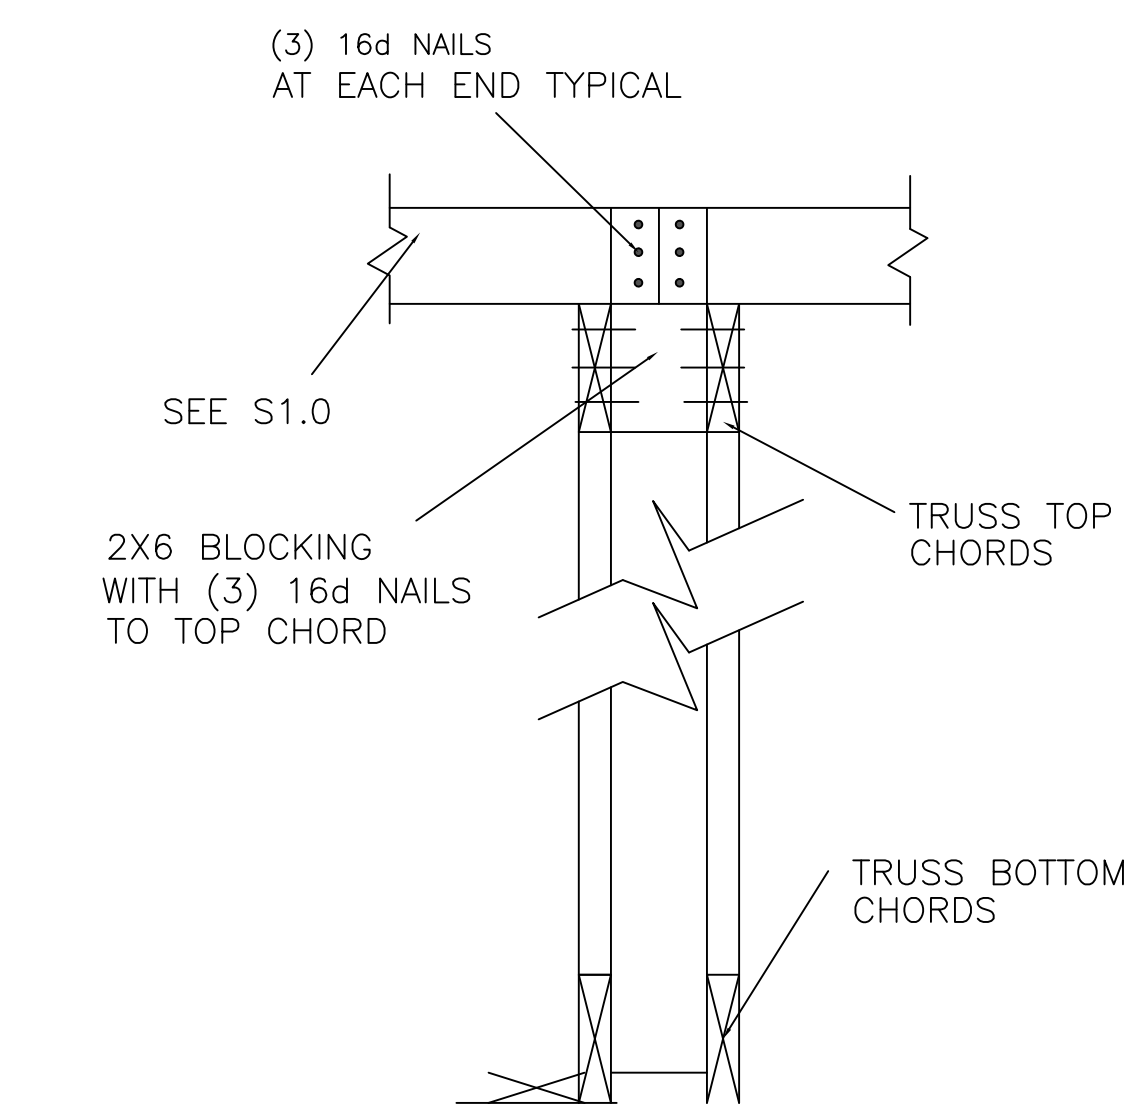


**4**  
S3.0 TYPICAL PURLIN TO TRUSS CONNECTION DETAIL

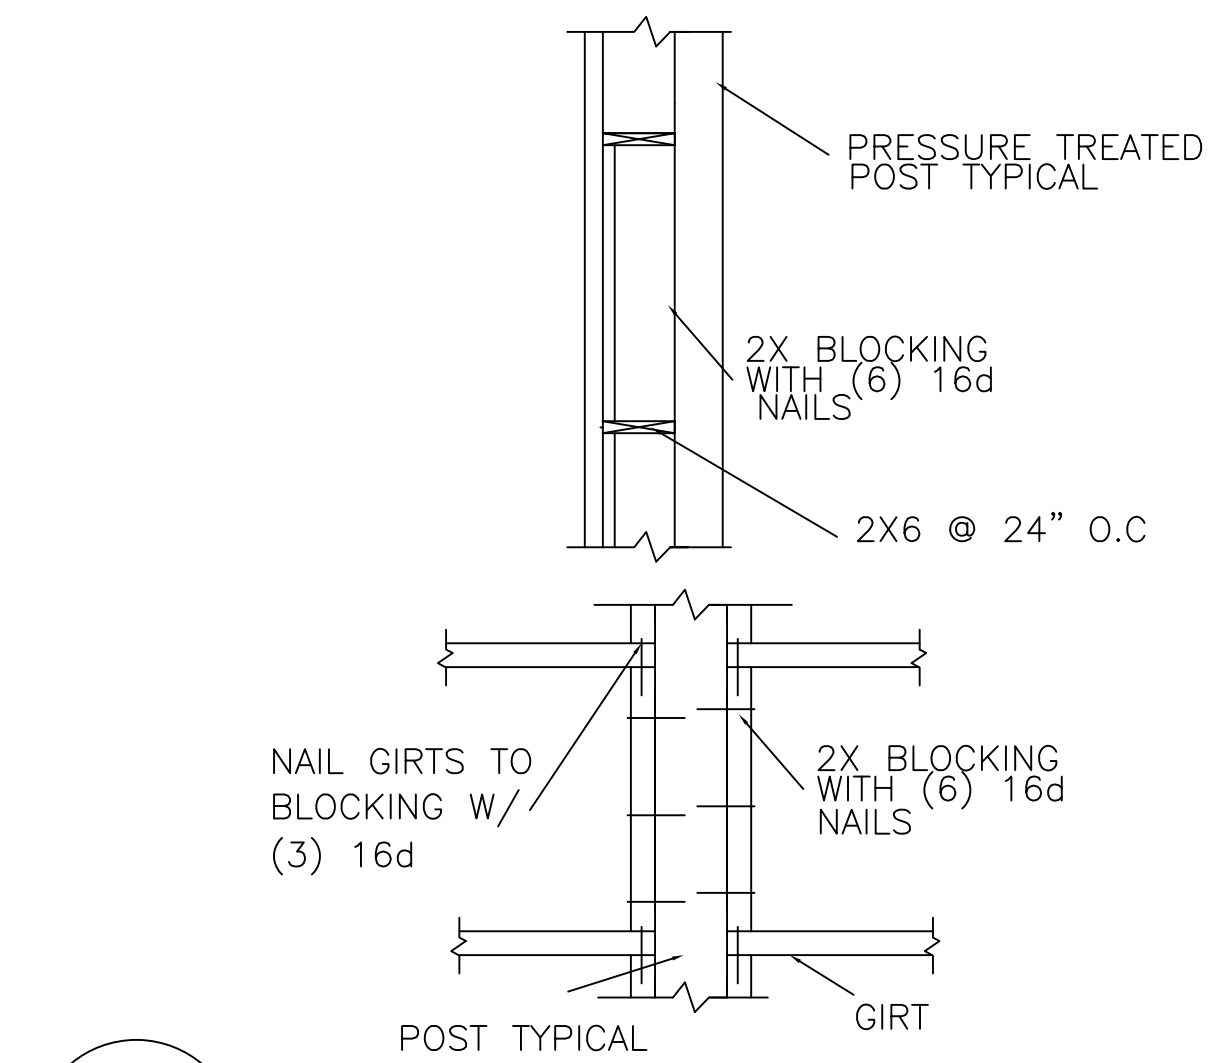


**5**  
S3.0 GIRTS TO POST CONNECTION DETAIL

- NOTES**
- ALL ROOF AND SIDE, AND GABLE WALL METAL SHEATHING, WHERE NOTED, SHALL BE MINIMUM 29 GAGE WITH RIP PATTERN AT 9" INTERVALS FASTEN METAL SHEATHING TO EACH GIRTS AND PURLIN AS SHOWN BELOW OR ACCORDING TO THE MANUFACTURER'S RECOMMENDATIONS WHICHEVER IS MORE RESTRICTIVE.
  - BLOCKING IS REQUIRED BETWEEN GIRTS AND PURLINGS IN ORDER TO COMPLY WITH SCREW SPACING AT CORNERS AND OPENINGS.
  - STITCH SCREWS MAY BE USED ON SEAM RIB IF DESIRED OR OTHERWISE REQUIRED BY DESIGN (SEE PLANS ), BUT NOT NECESSARY IF WALL AND ROOF PANEL LAPS ARE PLACED IN THE DIRECTION OF PREVAILING WIND.

PREVAILING WIND DIRECTION → APPLY IN THIS DIRECTION

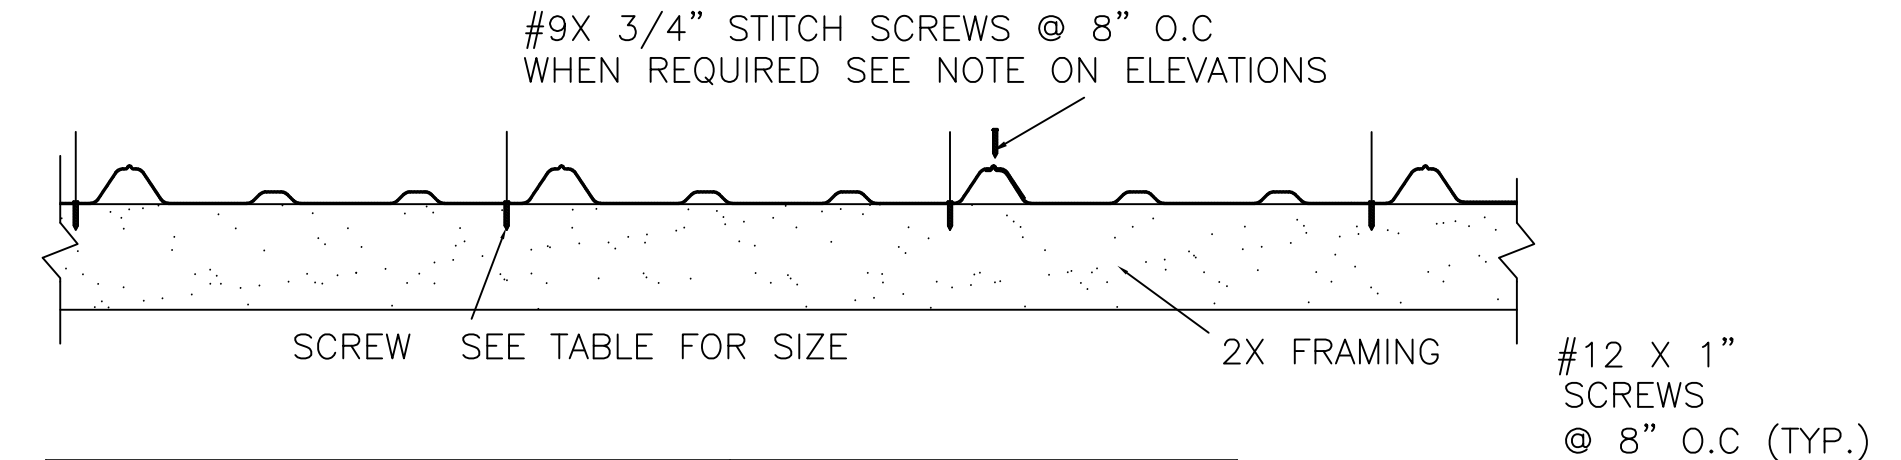


ROOF INTERMEDIATE PURLINS*	# 12 X 1" @ 9" O.C
SIDE WALL INTERMEDIATE GIRTS**	# 12 X 1" @ 9" O.C
GABLE WALL INTERMEDIATE GIRTS**	# 12 X 1" @ 9" O.C

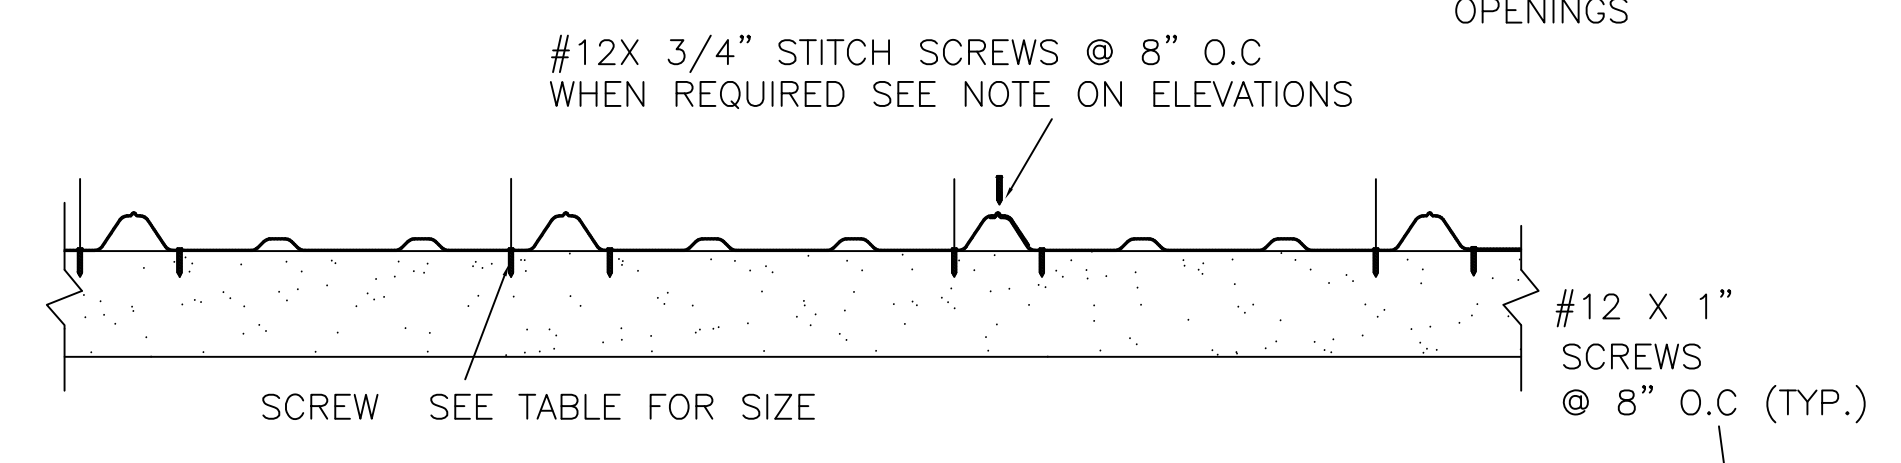

SIDE WALL EAVE AND SPLASH BOARD**	# 12 X 1-1/2"
GABLE WALL TRUSS TOP CHORD AND SPLASH BOARD**	# 12 X 1-1/2"
RIDGE**	# 12 X 1-1/2"

\*\* INCREASE THE LENGTH OF SCREWS BY 1/2" IF PLYWOOD OR OSB SHEATHING IS USED.

**6**  
S3.0 WALL AND ROOF SHEATHING FASTENING DETAIL

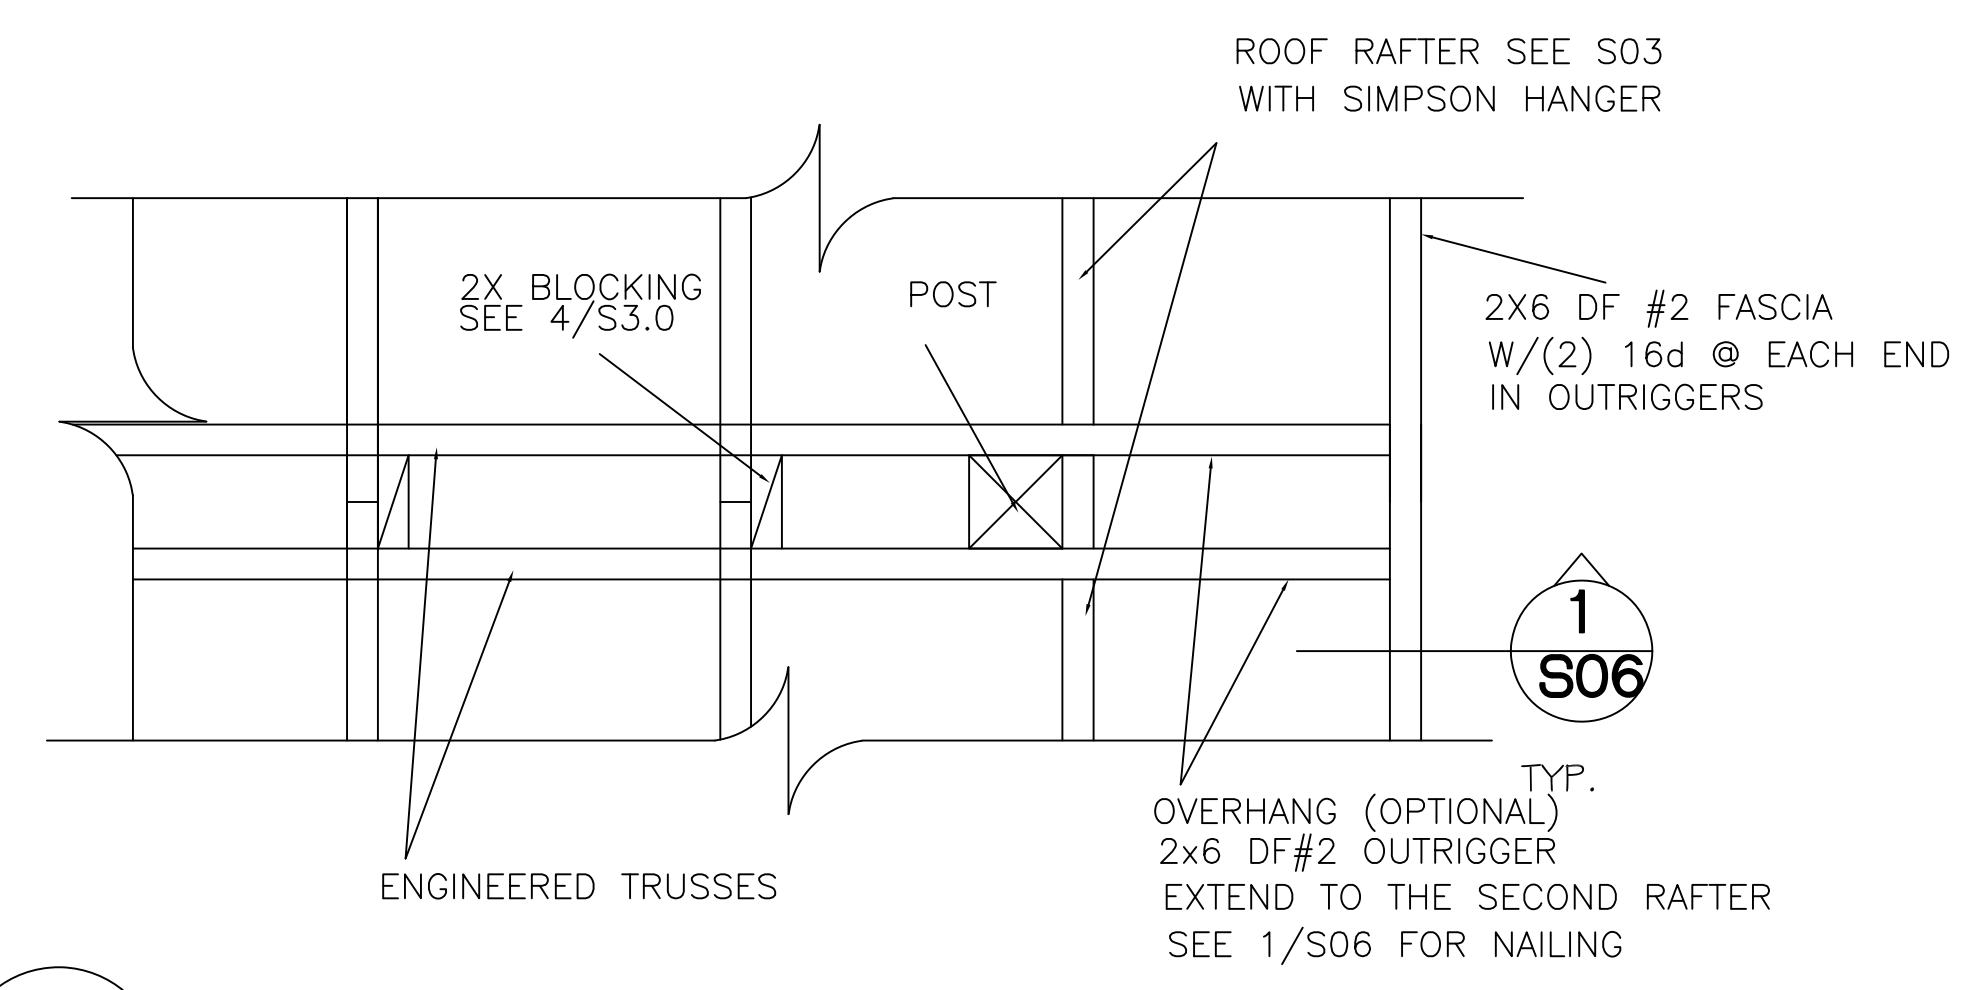

**7**  
S3.0 OUTRIGGER/OVERHANG DETAIL

### LIGHT FIXTURE SCHEDULE


- W2 LED WALL PACK LITHONIA WPX0 LED ALO4 8WU2 (4000) MVOLT DDBXD WITH PHOTOCELL. 13 WATTS
- Z4 4-FOOT LED LENSED STRIP, LITHONIA Z-SERIES ZLID L48 8MR 5000LM F8T 35K 80CRI OR APPROVED. 41 WATTS

PANEL 'A'														FAULT CURRENT = 6531													
100 AMP MAIN BREAKER														120 / 240 VOLTS		1-PHASE, 3-WIRE											
FEEDER SIZE														ALUMINUM: 1 1/2" C, 3 #10 PH, #6 GRD		FLUSH MOUNTED											
LOAD DISTRIBUTION														LTG	REC MOTOR	DATA	EXTG	HEAT	MISC	PH-A	PH-B	TOTAL	AMPS	WITH SPARE	25%		
CONNECTED VA														1977	2340	0	0	2000	0	3786	2531	6317	32	7896	39		
DIVERSITY FACTOR														125%	100%	100%	100%	65%	100%	100%	0	4258	2554	6811	35	8514	44
DIVERSIFIED VA														2471	2340	0	0	2000	0	4258	2554	6811	35	8514	44		

PL	T	LOAD	VA	HP	PHW	GND	CON	BKR	PH	BKR	CON	GND	PHW	HP	VA	LOAD	T	PL
1	H	HEATER	1000		12	12	1/2	20	2	A	1	20	1/2	12	12	1640	LTS: CAGES	L 2
3	H		1000							B	1	20	1/2	12	12	91	LTS: EXTERIOR	L 4
5	R	REC: TEAM ROOM	180		12	12	1/2	20	1	A	1	20	1/2	12	12	360	REC: CAGES	R 6
7	R	REC: EQUIP STORE	720		12	12	1/2	20	1	B	1	20	1/2	12	12	360	REC: CAGES	R 8
9	L	LTS: TEAM / STORE	246		12	12	1/2	20	1	A	1	20	1/2	12	12	360	REC: CAGES	R 10
11										B	1	20	1/2	12	12	360	REC: CAGES	R 12
13										A								14
15										B								16
17										A								18
19										B								20
21										A								22
23										B								24

**A** ALL CIRCUIT CONDUCTORS SIZED FOR COPPER  
10/9/2023  
FED FROM UTILITY TRANSFORMER 23.07 Schedules


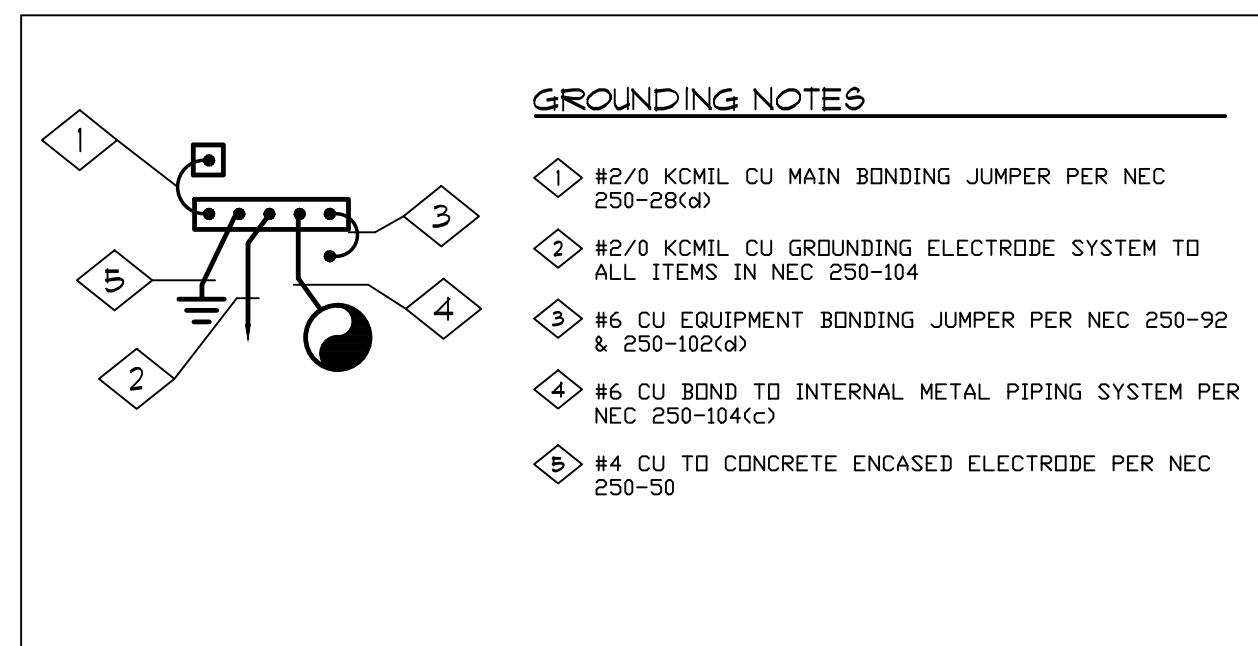


### 3 1-LINE DIAGRAM

E1 120/240 VOLT, 1-PH

### 4 GROUNDING DETAIL

E1 DIAGRAMMATIC

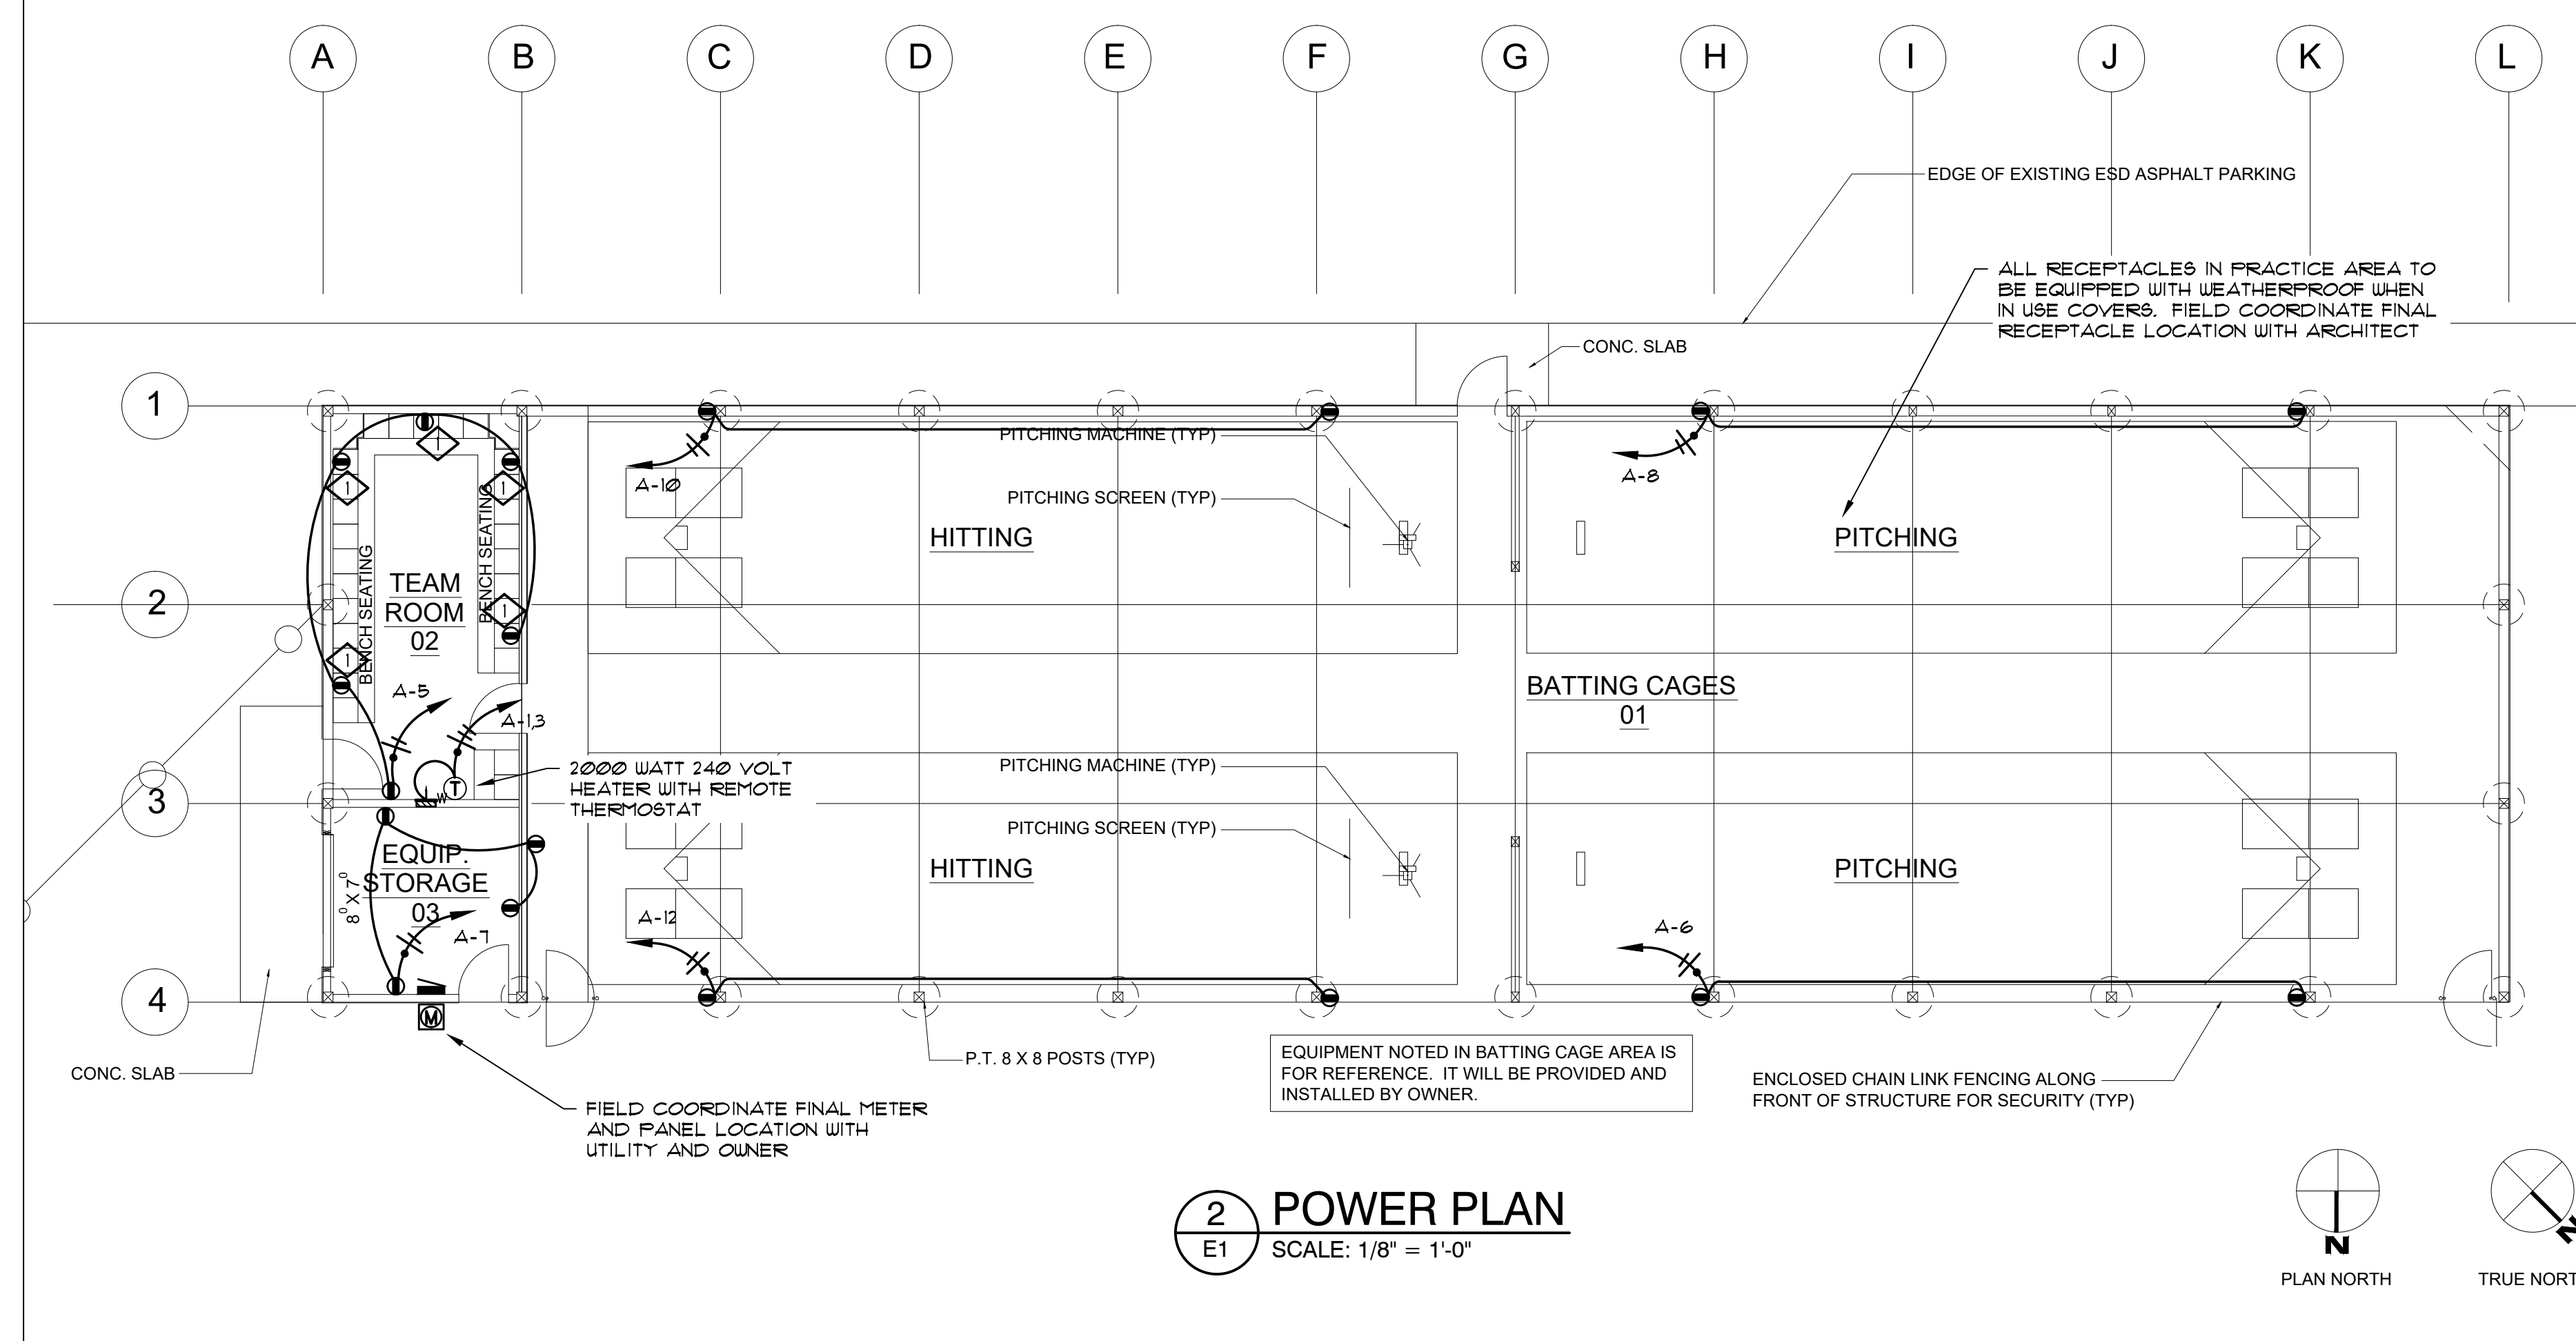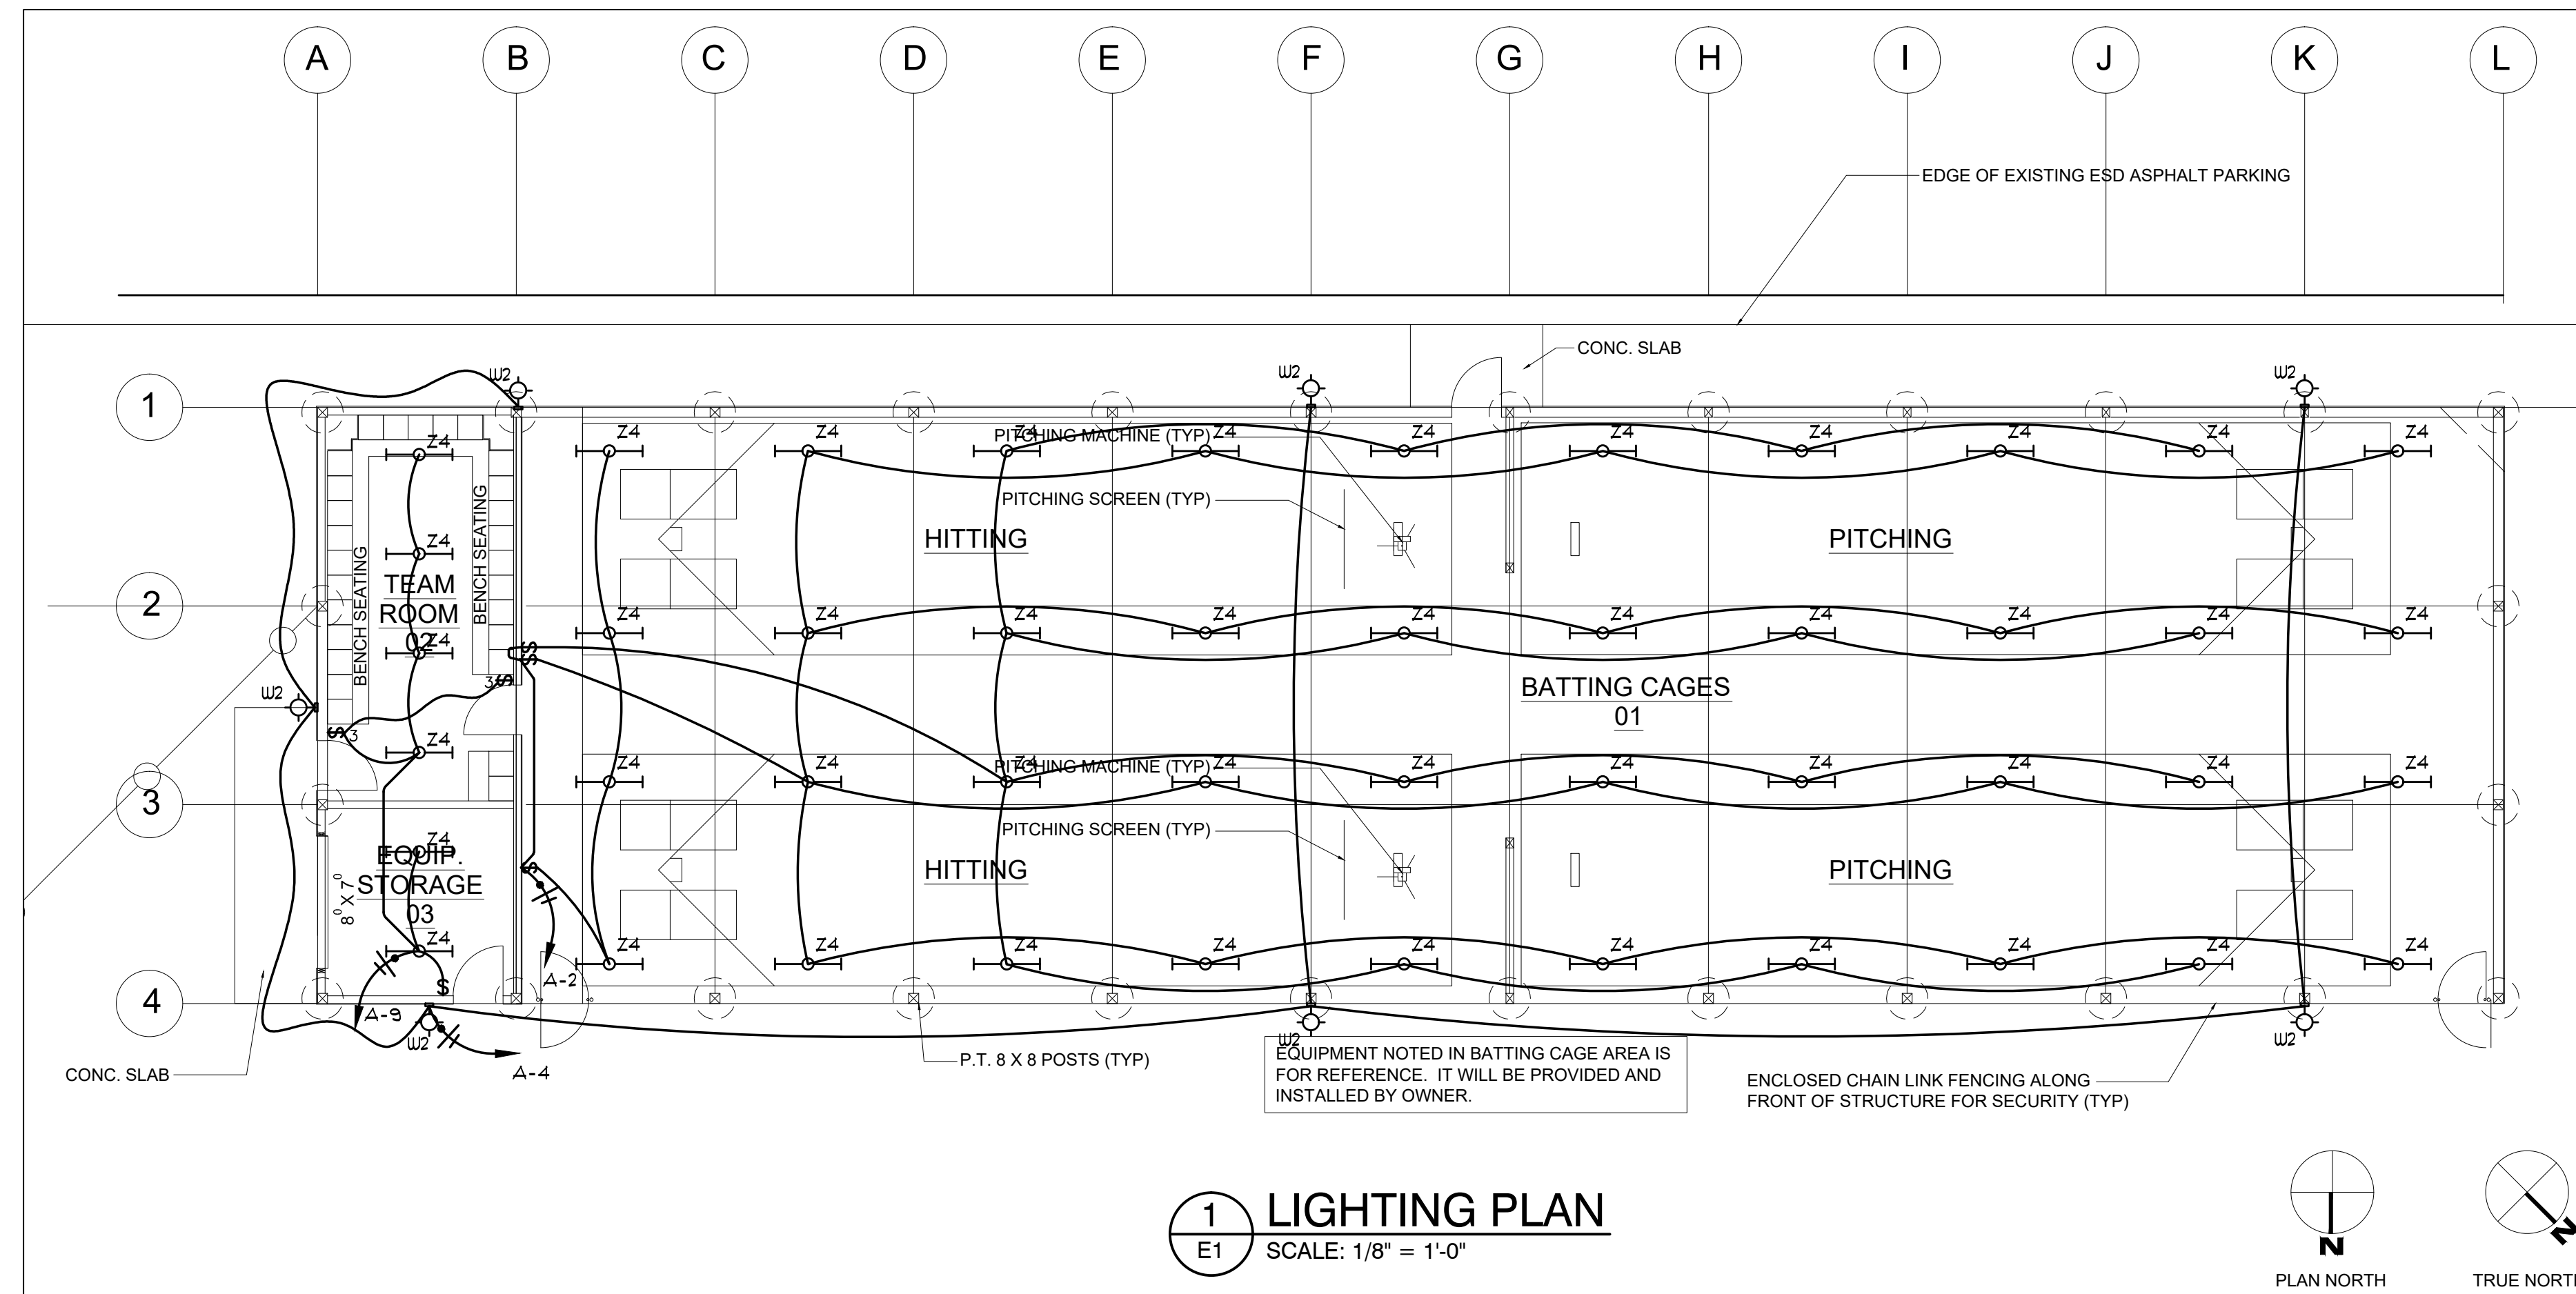

### KEYED NOTES

- RECEPTACLES AT LOCKERS ARE INTENDED TO BE MOUNTED 6" ABOVE LOCKERS. FIELD COORDINATE FINAL RECEPTACLE LOCATION AND MOUNTING HEIGHT WITH OWNER PRIOR TO ROUGH-IN TO ACCOMMODATE LOCKER INSTALLATION.

### PROJECT NOTES

1. ELECTRICAL SERVICE: FIELD COORDINATE ELECTRICAL SERVICE WITH OWNER AND UTILITY.
2. EXISTING SERVICE: IF FEEDING FROM EXISTING BUILDING / SERVICE, PROVIDE GROUNDING CONDUCTOR IN FEEDER. ALSO PROVIDE APPROVED GROUNDING RODS AT BATTING CAGES. MAINTAIN ISOLATION OF GROUND BUS FROM NEUTRAL BUS. VERIFY ADEQUATE CAPACITY IN EXISTING PANEL FOR ADDITIONAL LOAD PER NEC REQUIREMENTS. FIELD COORDINATE ALL REQUIREMENTS.
3. NEW UTILITY SERVICE: IF PROVIDING NEW UTILITY SERVICE, GROUND AND BOND PER NEC. FIELD COORDINATE ALL REQUIREMENTS WITH SERVING UTILITY.

### CONSTRUCTION

REVISIONS:  
# DATE DESCRIPTION

DATE: OCTOBER 2023

SHEET TITLE:

**ELECTRICAL PLAN**

**E1**